


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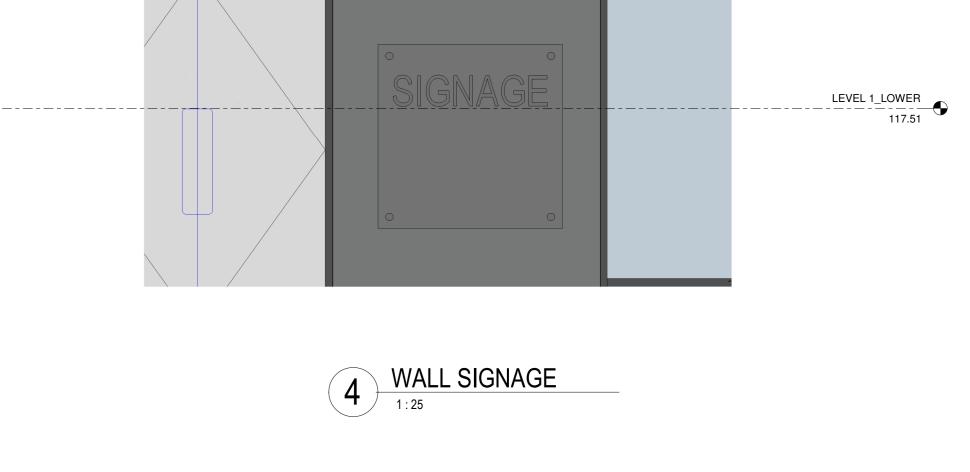
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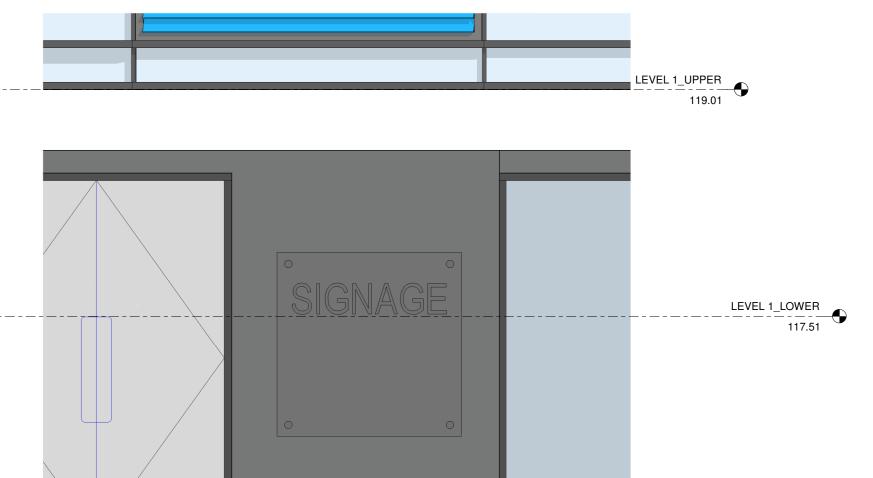
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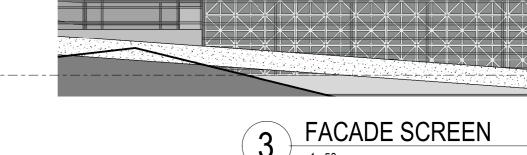


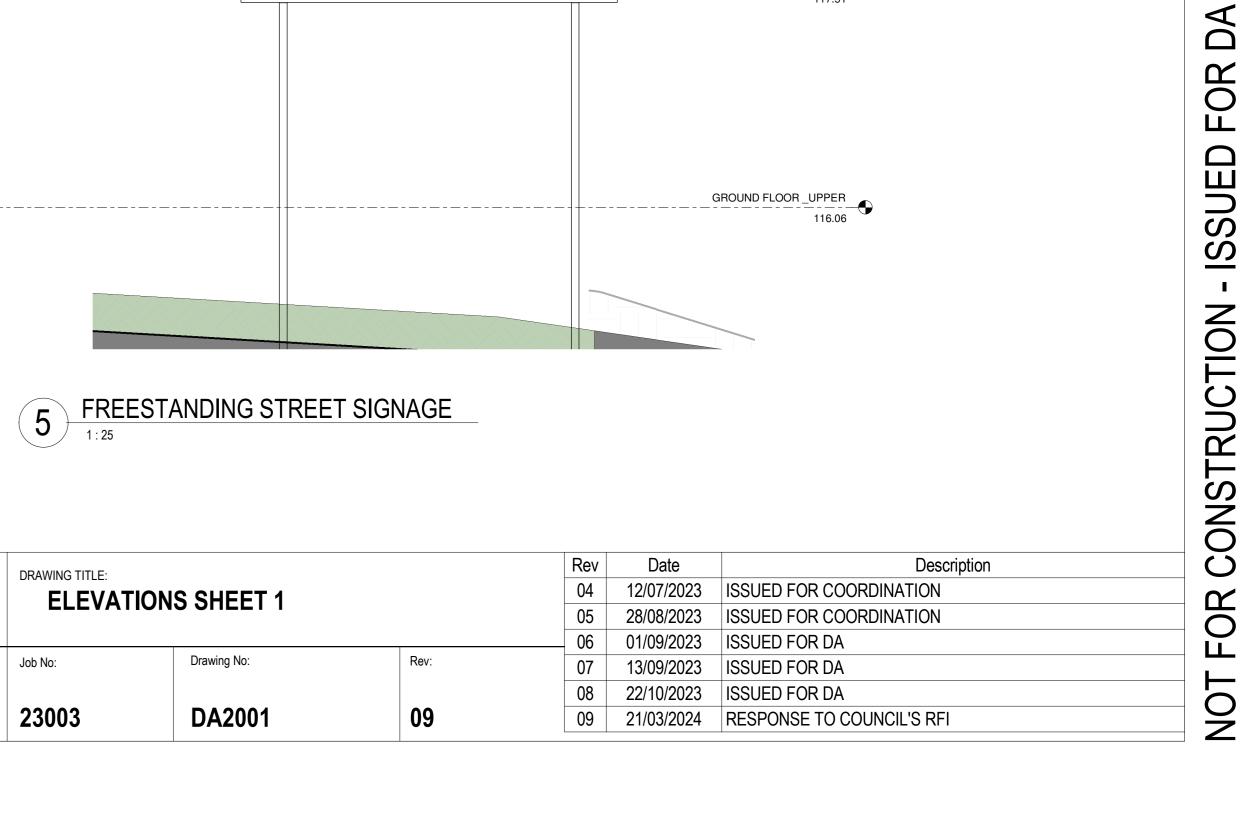











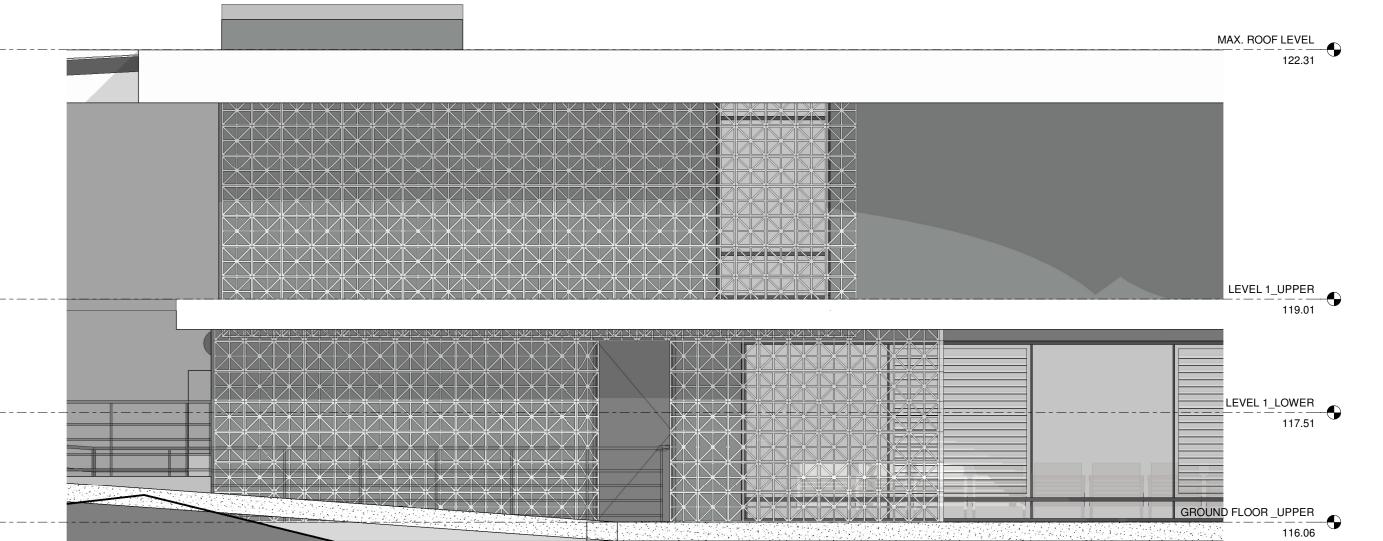

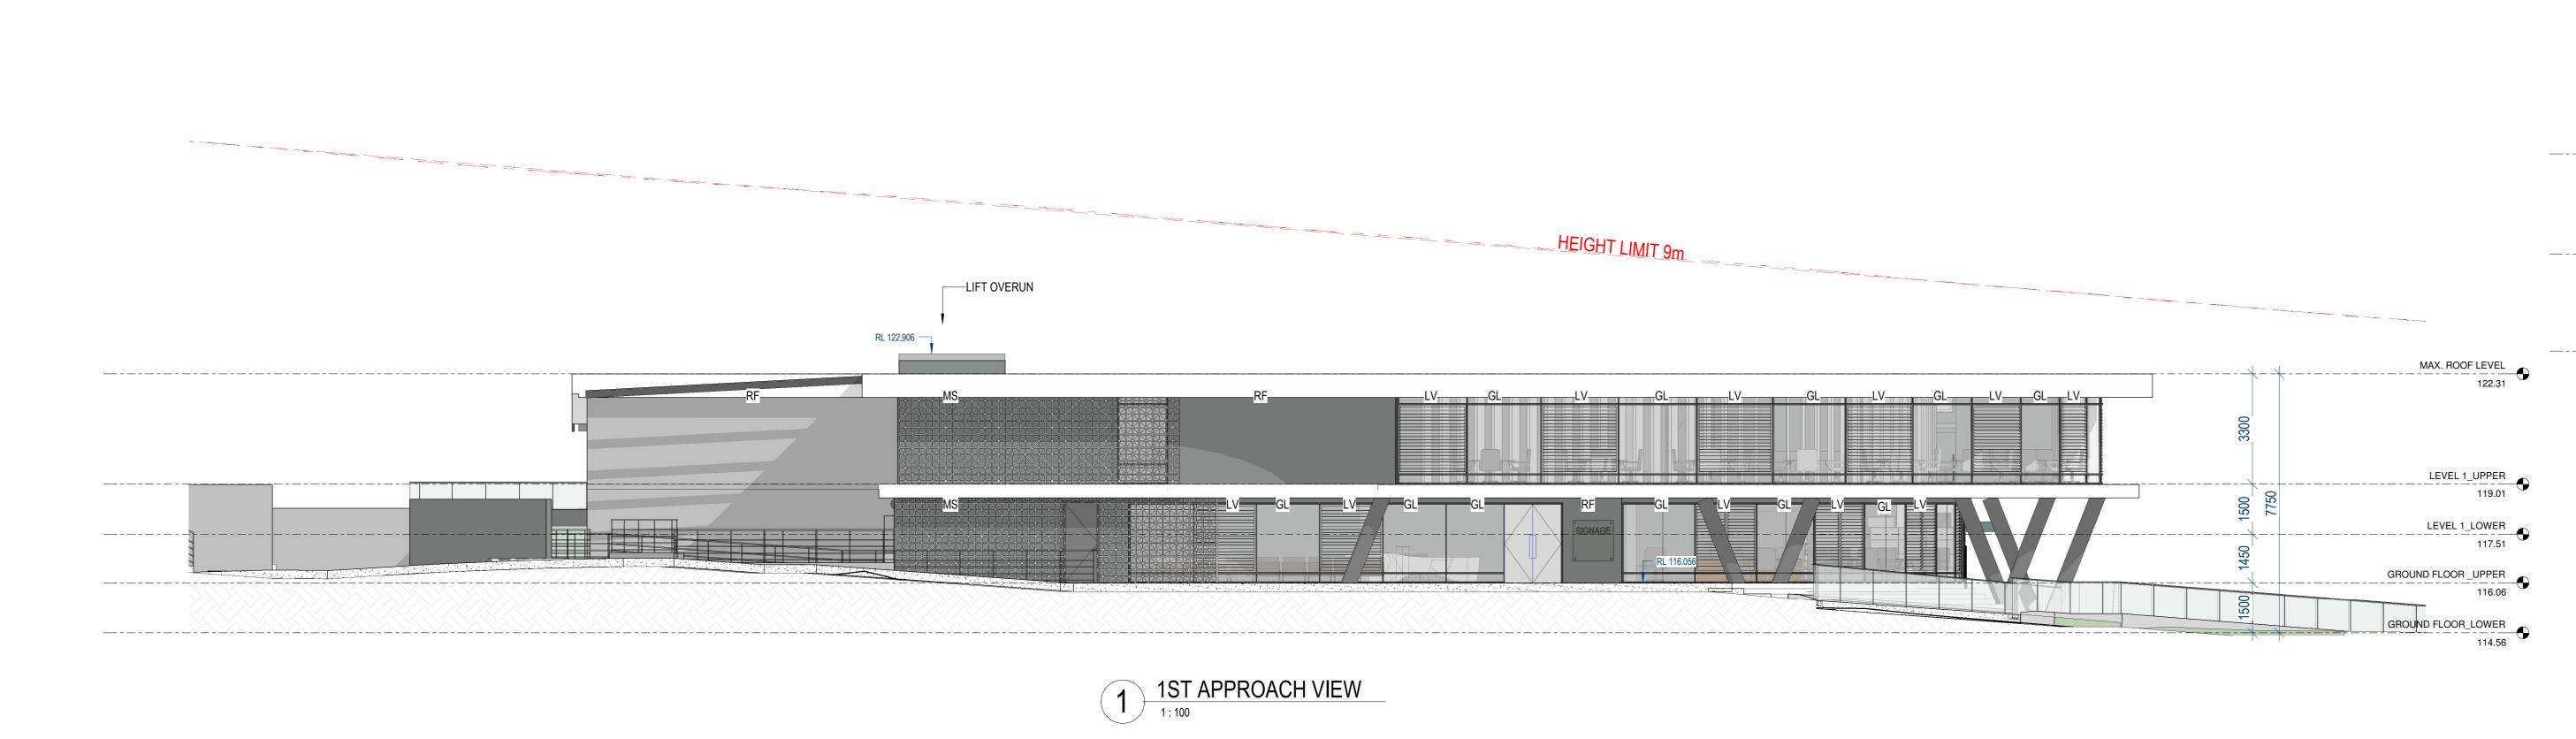

WITH CONSULTING ENGINEERS AND SUBCONTRACTORS - INCLUDING SET-OUT, LOCATIONS AND QUANTITIES 0 10 20 30 40 50 60 70 80 90 100 110 120 130 140 150

1. DO NOT SCALE. USE FIGURED DIMENSIONS ONLY. VERIFY ALL LEVELS AND DIMENSIONS ON SITE BEFORE

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COMMENCING CONSTRUCTION, FABRICATION, OR SHOP DRAWINGS.

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EXISTING DEVELOPMENT

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PROPOSED COMMUNITY CENTRE

CLIENT'S ADDRESS: 1 Wentworth St, GreenacreNSW, 2190, Australia. 221 EAGLESVIEW ROAD, MINTO NSW 2566

RAHIMA AZIZ FOUNDATION LIMITED

2 2ND APPROACH VIEW (VIA EAGLEVIEW ROAD)
1:100

SYMS 9/33 Albert Street, North Parramatta NSW 2151. ABN 19 667 132 078

Architects

FACADE BEHIND

Designer Checked by


ORIGINAL ARCHITECTS:

As indicated


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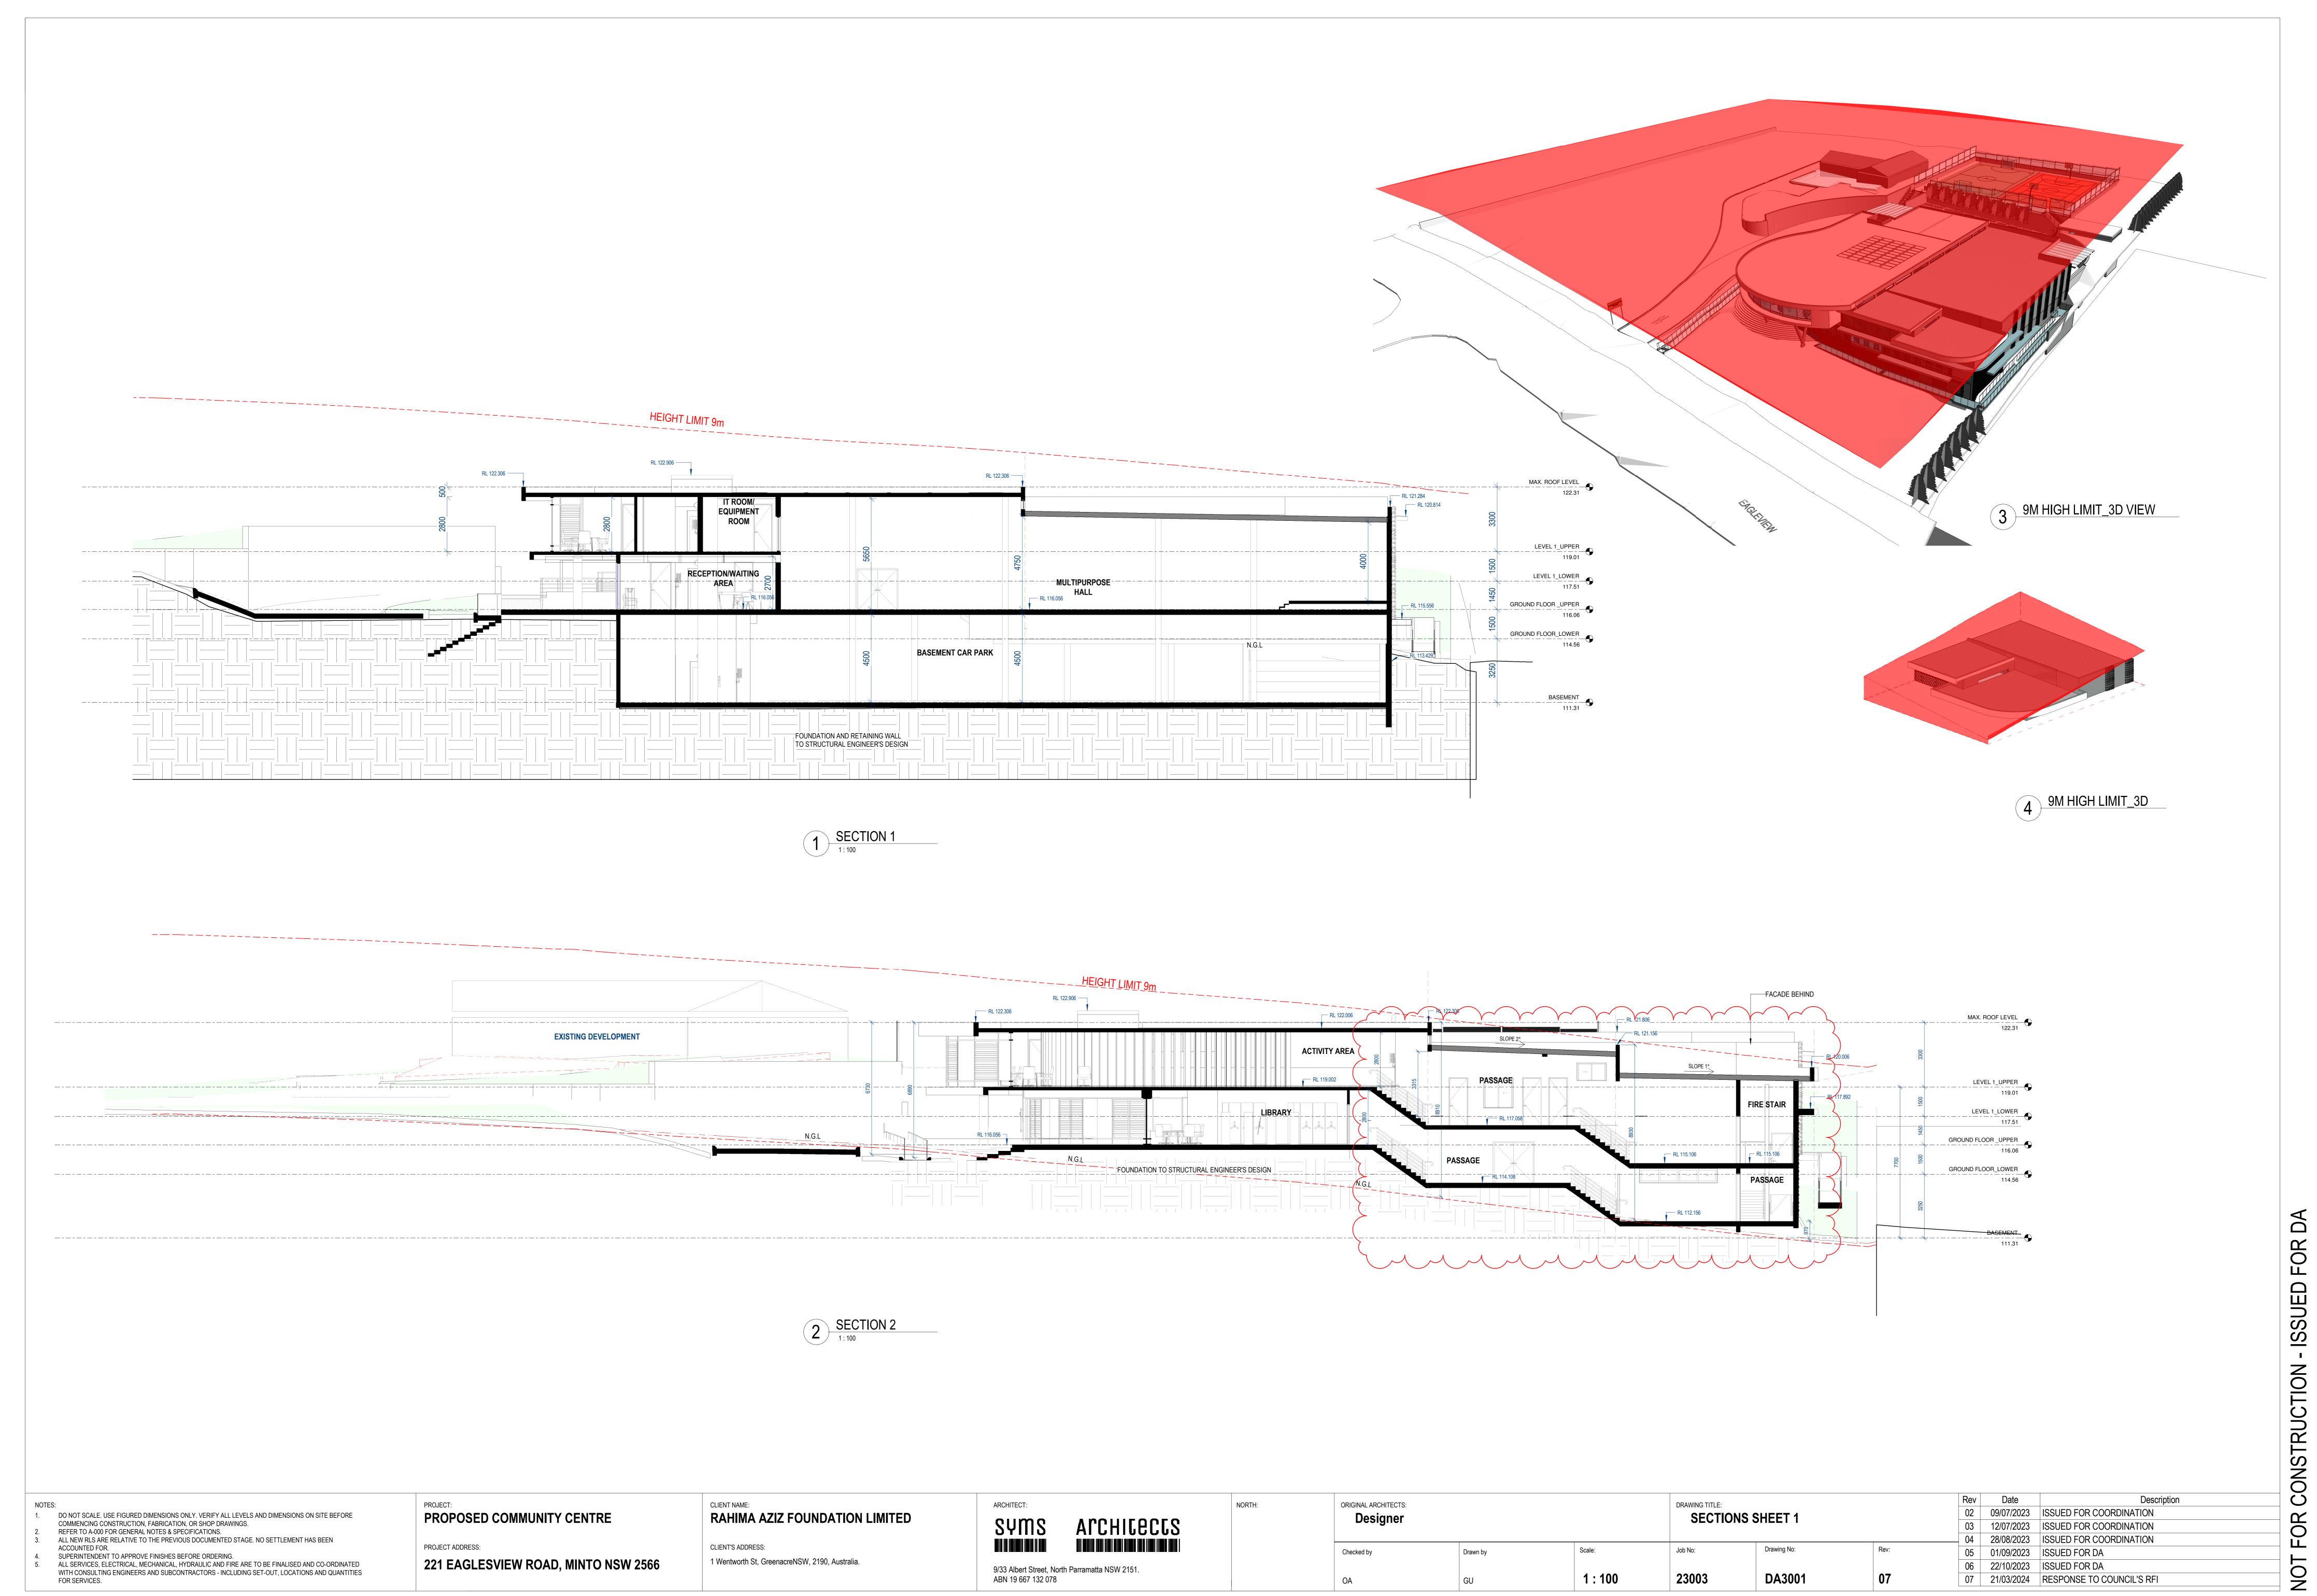
PROJECT ADDRESS:



1 REAR VIEW (FROM EAGLEVIEW ROAD)

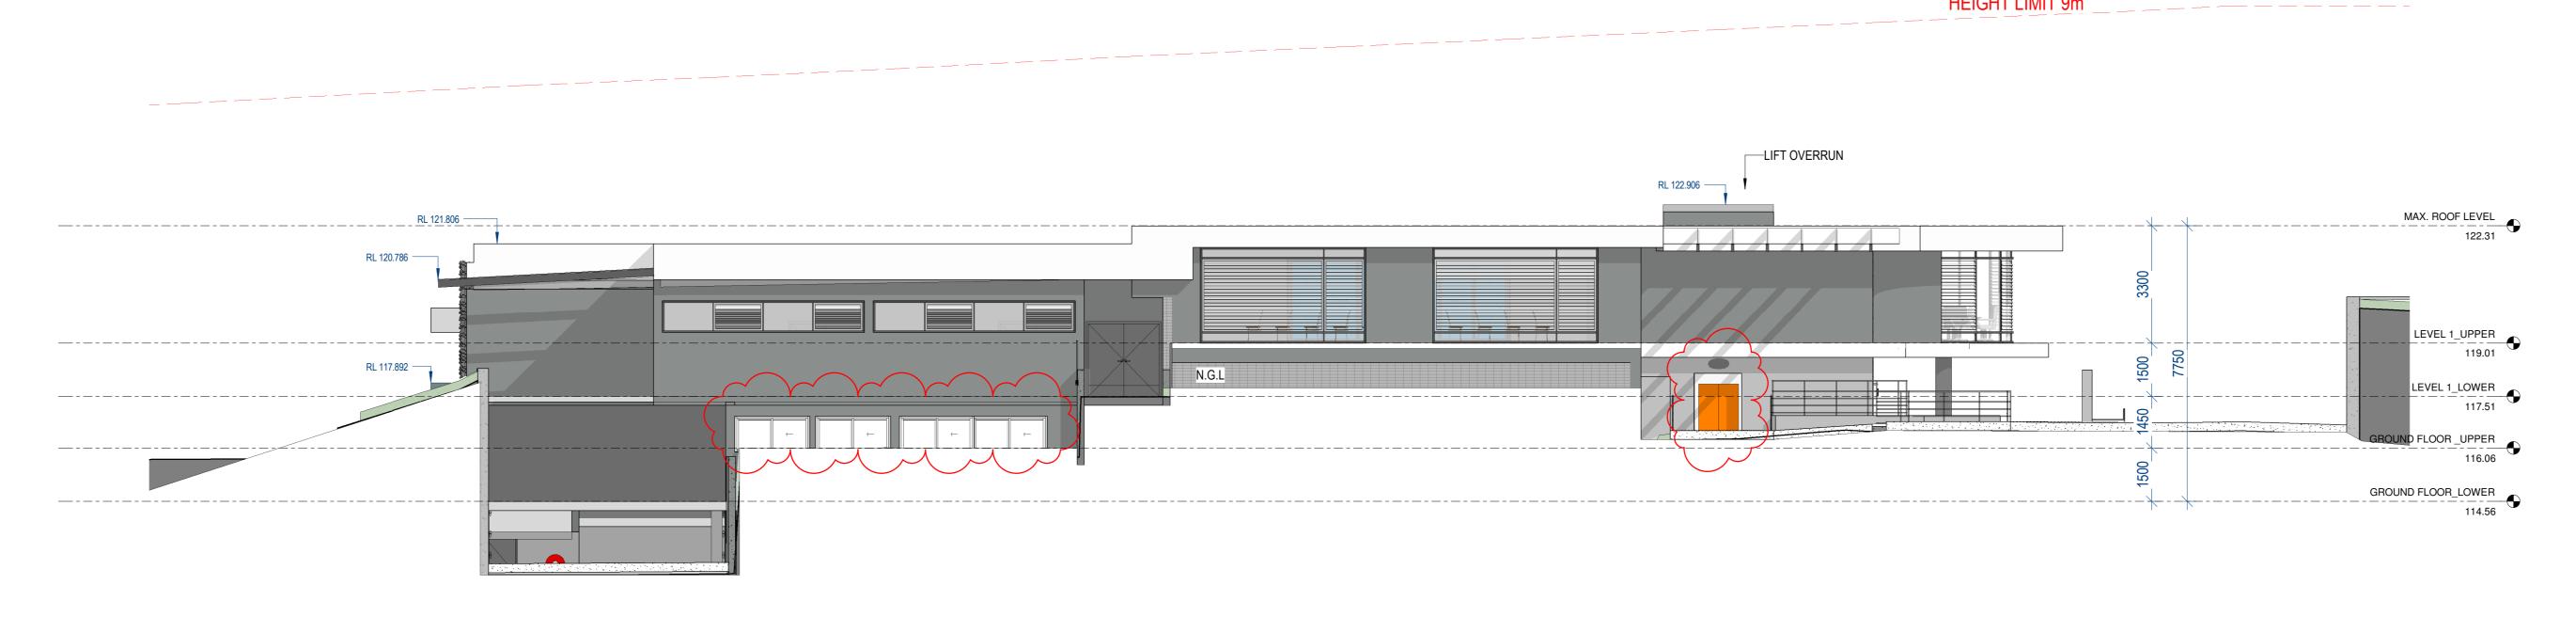


ORIGINAL ARCHITECTS: DRAWING TITLE: 04 12/07/2023 ISSUED FOR COORDINATION **ELEVATIONS SHEET 2** PROPOSED COMMUNITY CENTRE 1. DO NOT SCALE. USE FIGURED DIMENSIONS ONLY. VERIFY ALL LEVELS AND DIMENSIONS ON SITE BEFORE RAHIMA AZIZ FOUNDATION LIMITED Designer Archicects SYMS 05 28/08/2023 ISSUED FOR COORDINATION COMMENCING CONSTRUCTION, FABRICATION, OR SHOP DRAWINGS. REFER TO A-000 FOR GENERAL NOTES & SPECIFICATIONS. 06 01/09/2023 ISSUED FOR DA ALL NEW RLS ARE RELATIVE TO THE PREVIOUS DOCUMENTED STAGE. NO SETTLEMENT HAS BEEN PROJECT ADDRESS: CLIENT'S ADDRESS: Drawing No: 07 13/09/2023 ISSUED FOR DA Job No: Checked by SUPERINTENDENT TO APPROVE FINISHES BEFORE ORDERING. 221 EAGLESVIEW ROAD, MINTO NSW 2566 1 Wentworth St, GreenacreNSW, 2190, Australia. ALL SERVICES, ELECTRICAL, MECHANICAL, HYDRAULIC AND FIRE ARE TO BE FINALISED AND CO-ORDINATED 08 | 22/10/2023 | ISSUED FOR DA 9/33 Albert Street, North Parramatta NSW 2151. WITH CONSULTING ENGINEERS AND SUBCONTRACTORS - INCLUDING SET-OUT, LOCATIONS AND QUANTITIES 23003 DA2002 1:100 09 21/03/2024 RESPONSE TO COUNCIL'S RFI ABN 19 667 132 078

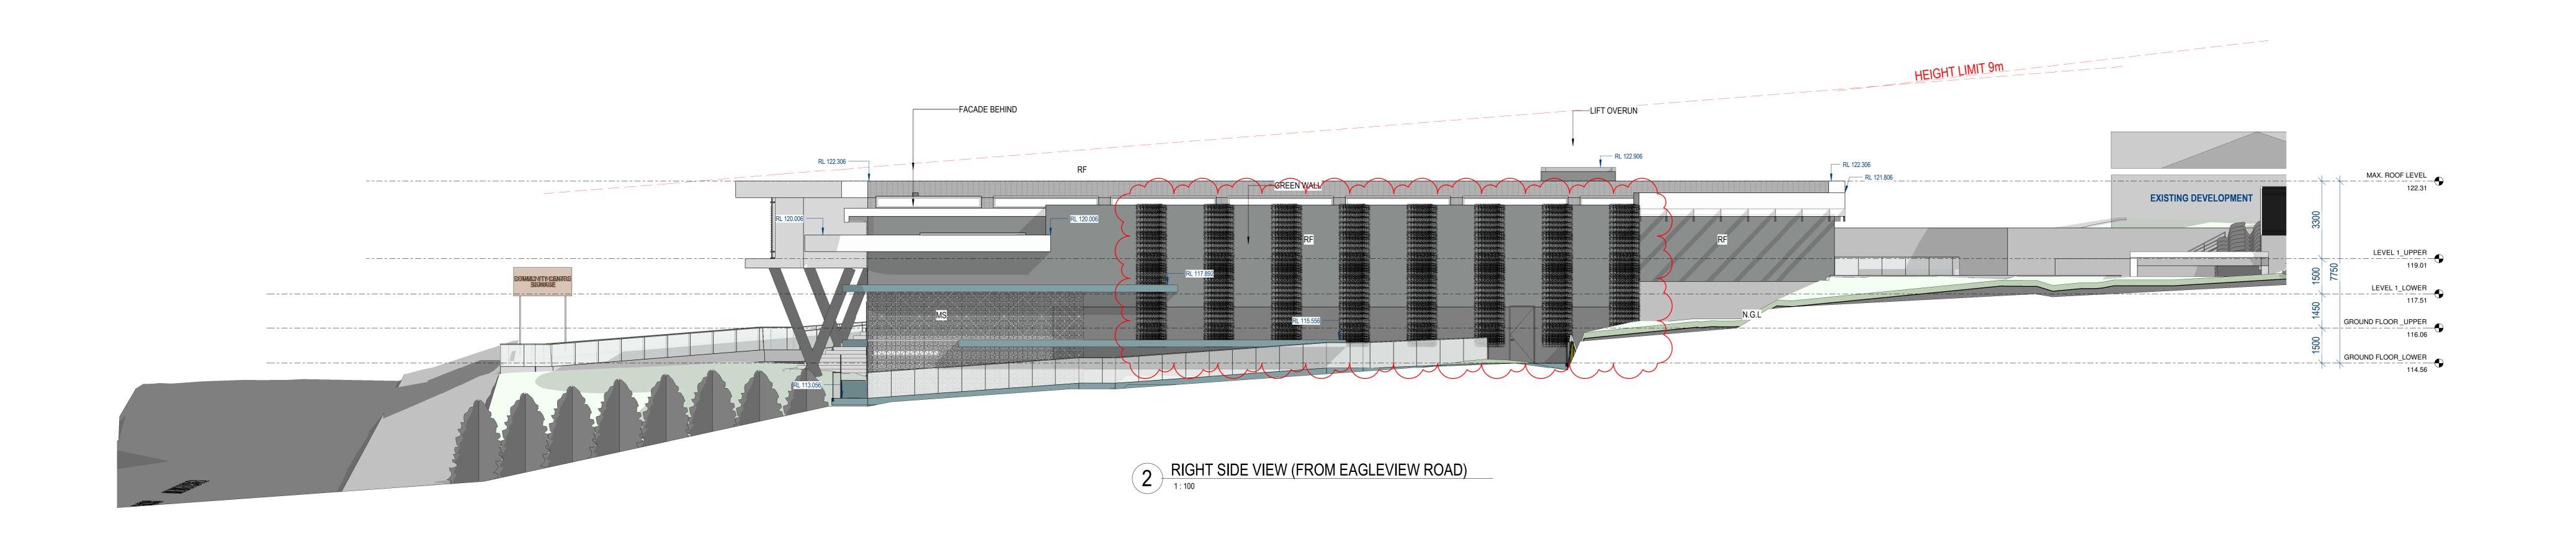

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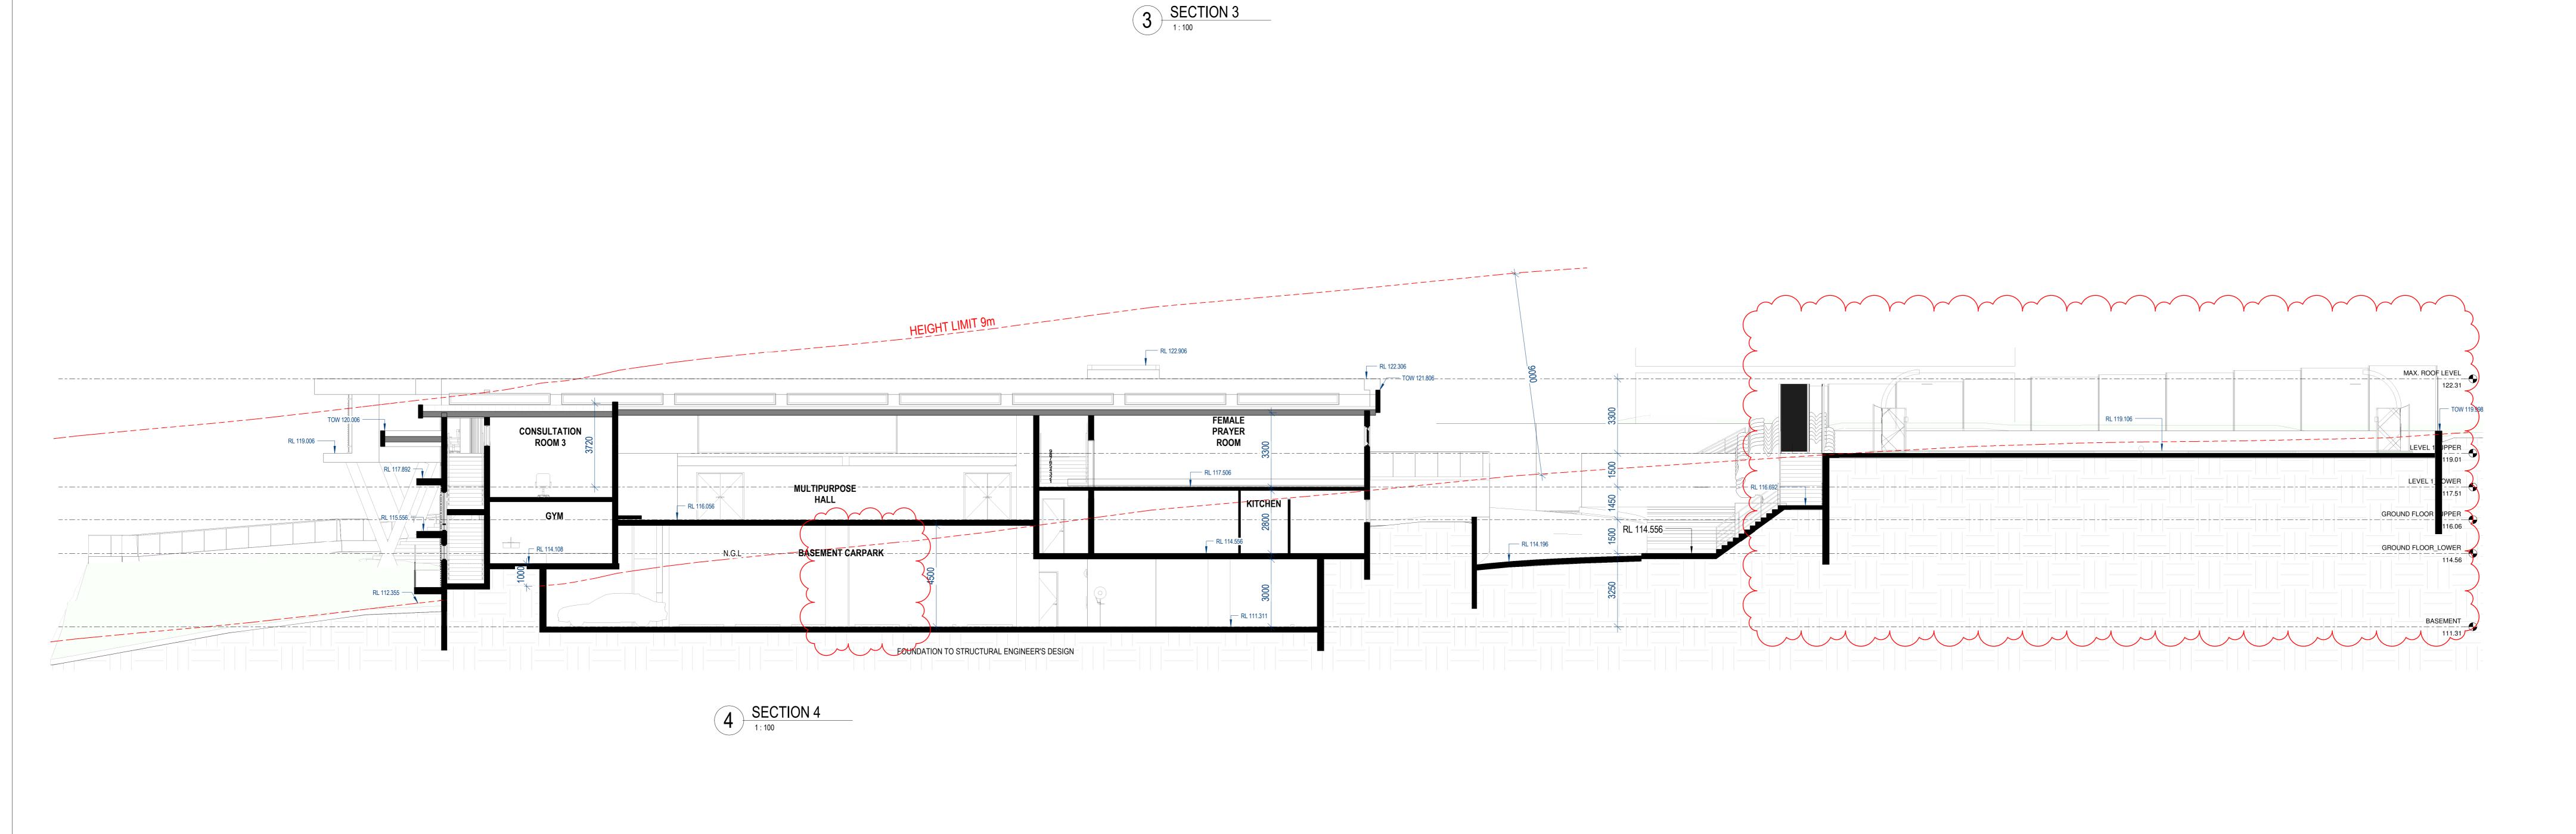
04 28/08/2023 ISSUED FOR COORDINATION

07 21/03/2024 RESPONSE TO COUNCIL'S RFI

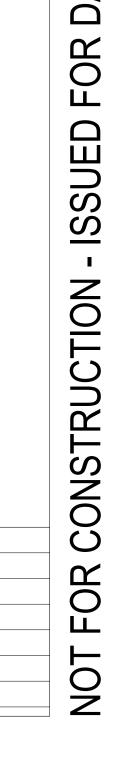08 22/05/2024 RESPONSE TO COUNCIL'S RF

05 01/09/2023 ISSUED FOR DA

06 22/10/2023 ISSUED FOR DA



Archicects

SYMS

ABN 19 667 132 078

9/33 Albert Street, North Parramatta NSW 2151.

RL 111.306 ——

PLANT ROOM

RL 116.359

RAHIMA AZIZ FOUNDATION LIMITED

1 Wentworth St, GreenacreNSW, 2190, Australia.

CLIENT'S ADDRESS:

ACTIVITY AREA

LEVEL 1_UPPER

GROUND FLOOR UPPER
116.06

DRAWING TITLE:

Job No:

1:100

23003

SECTIONS SHEET 2

Drawing No:

DA3002

LIFT OVERRUN

ORIGINAL ARCHITECTS:

Checked by

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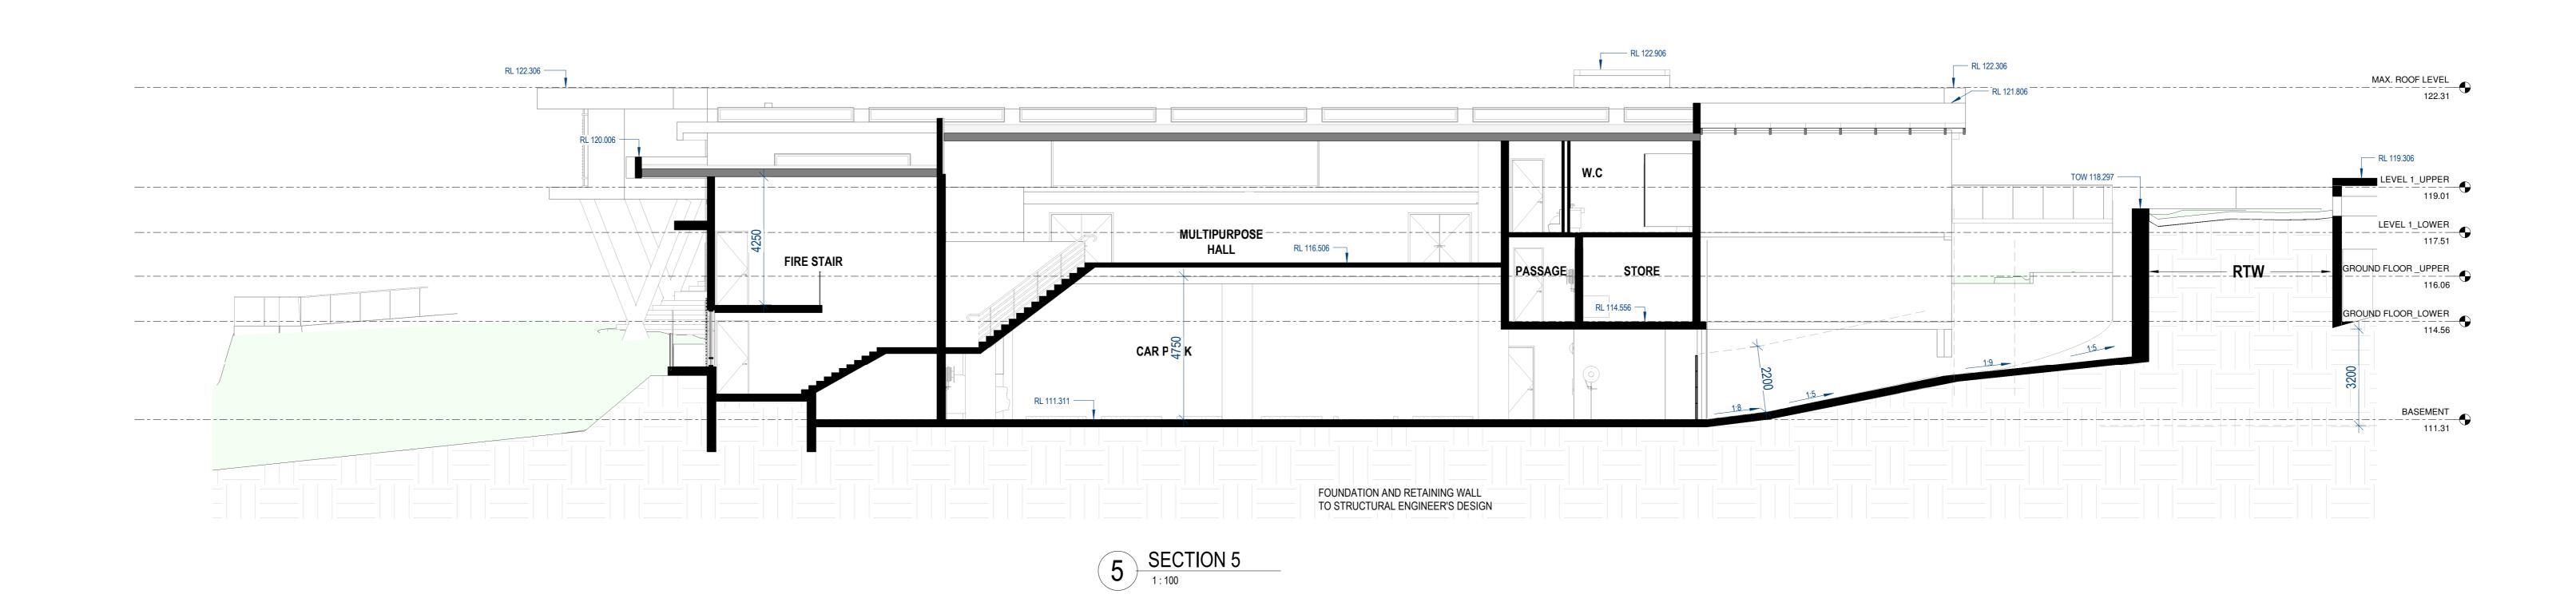
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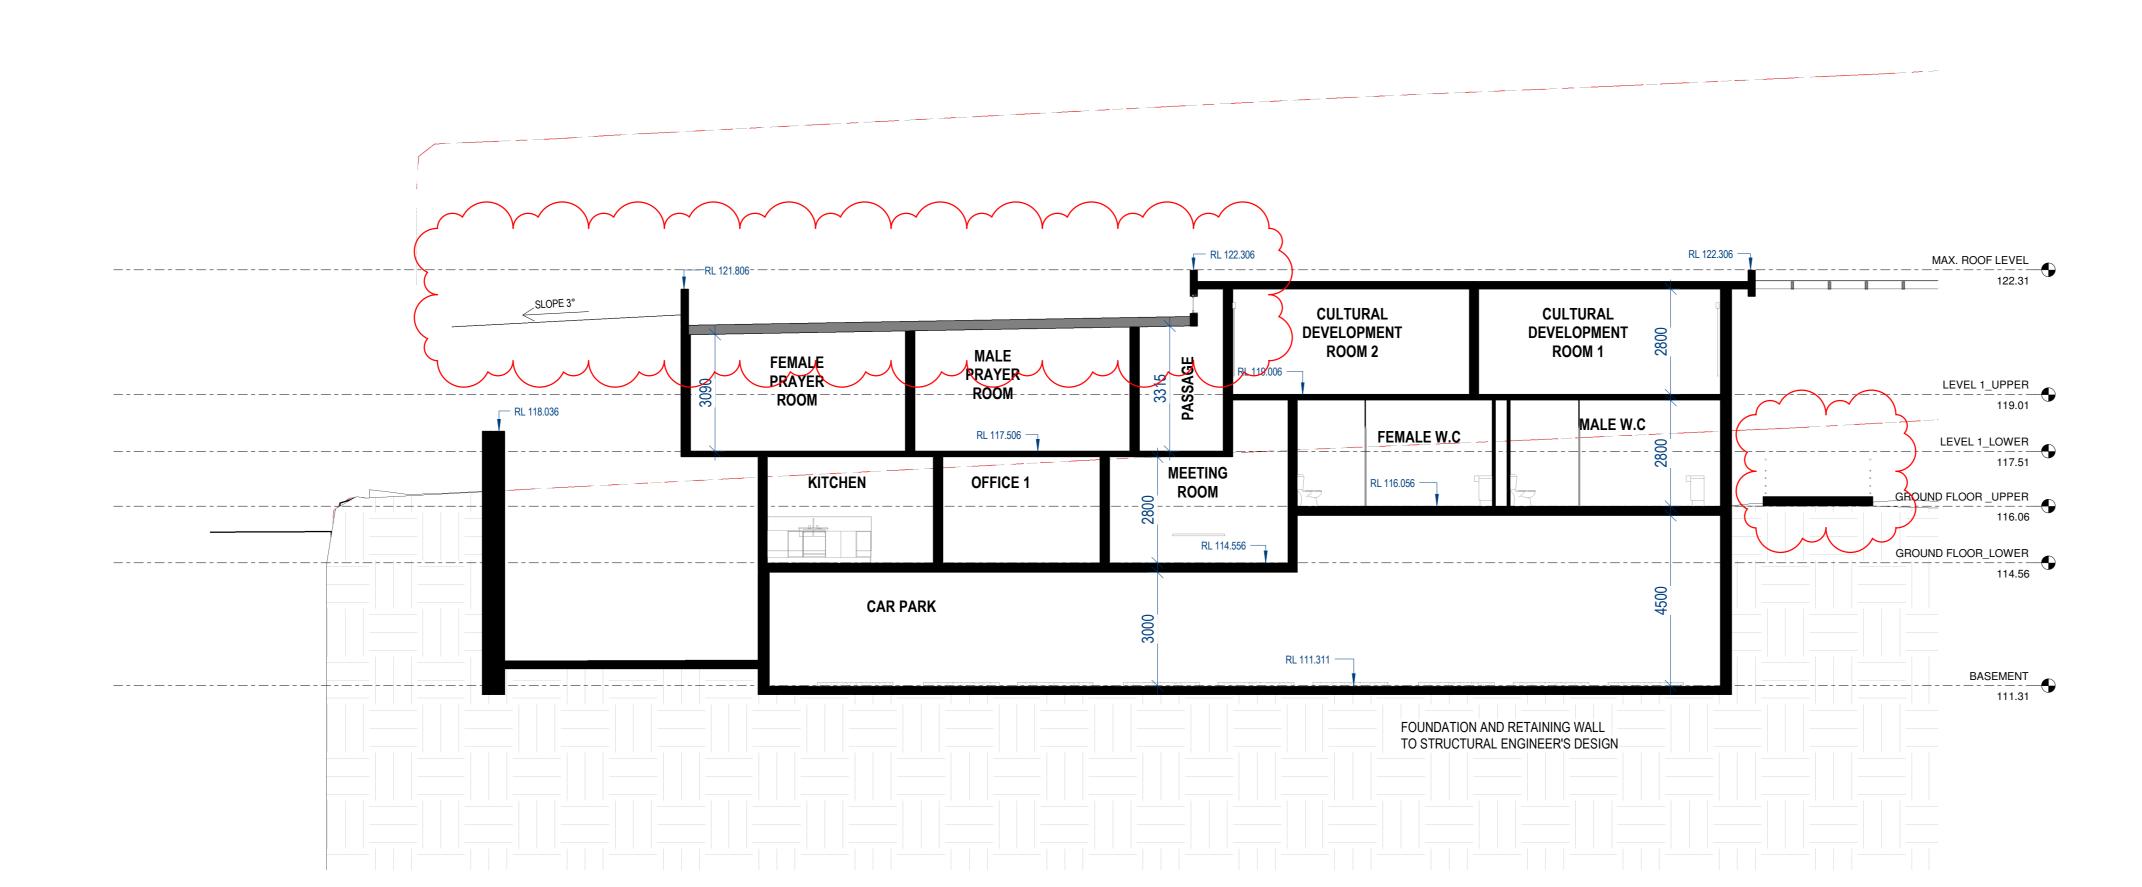
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221 EAGLESVIEW ROAD, MINTO NSW 2566

PROJECT ADDRESS:







6 SECTION 6

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ACCOUNTED FOR. 4. SUPERINTENDENT TO APPROVE FINISHES BEFORE ORDERING.	PROJECT ADDRESS:	CLIENT'S ADDRESS:			Checked by	Drawn by	Scale:	Job No:	Drawing No:	Rev:	03	21/03/2024 RESPONSE TO COUNCIL'S RFI	U
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TOW 120.316 —— RAMP UP 1:27 8 SECTION 8 (DRIVEWAY SLOPE)
1:100

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RAHIMA AZIZ FOUNDATION LIMITED

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CLIENT'S ADDRESS:

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1:100

Drawing No: DA3004

GROUND FLOOR_LOWER

114.56

01 28/08/2023 ISSUED FOR COORDINATION 02 01/09/2023 ISSUED FOR DA 03 13/09/2023 ISSUED FOR DA 04 22/10/2023 ISSUED FOR DA 05 21/03/2024 RESPONSE TO COUNCIL'S RFI

ORIGINAL ARCHITECTS: DRAWING TITLE: **SECTIONS SHEET 4** Job No: 23003




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01 13/09/2023 ISSUED FOR DA

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03 21/03/2024 RESPONSE TO COUNCIL'S RFI



NORTH:

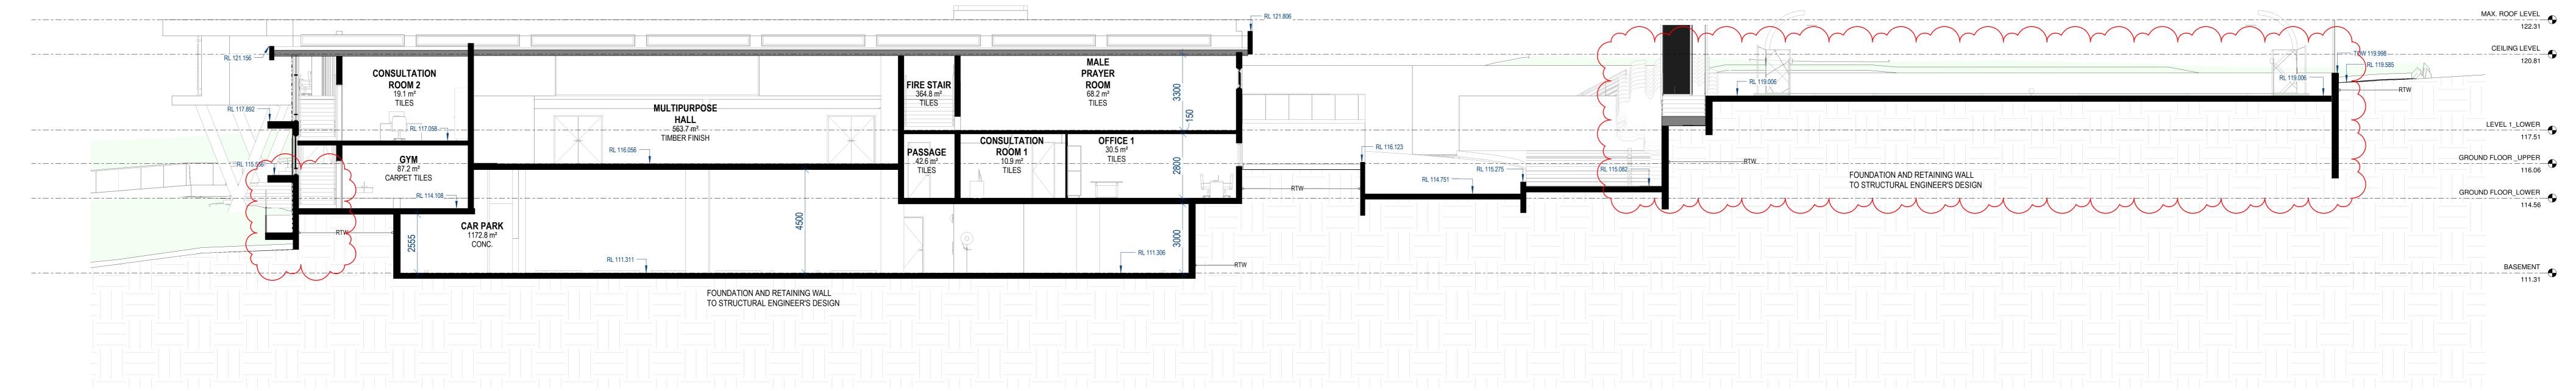ORIGINAL ARCHITECTS:

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DRAWING TITLE:

Job No:

1:100

23003

SECTIONS SHEET 5

Drawing No:

DA3005

ARCHITECT:

SYMS

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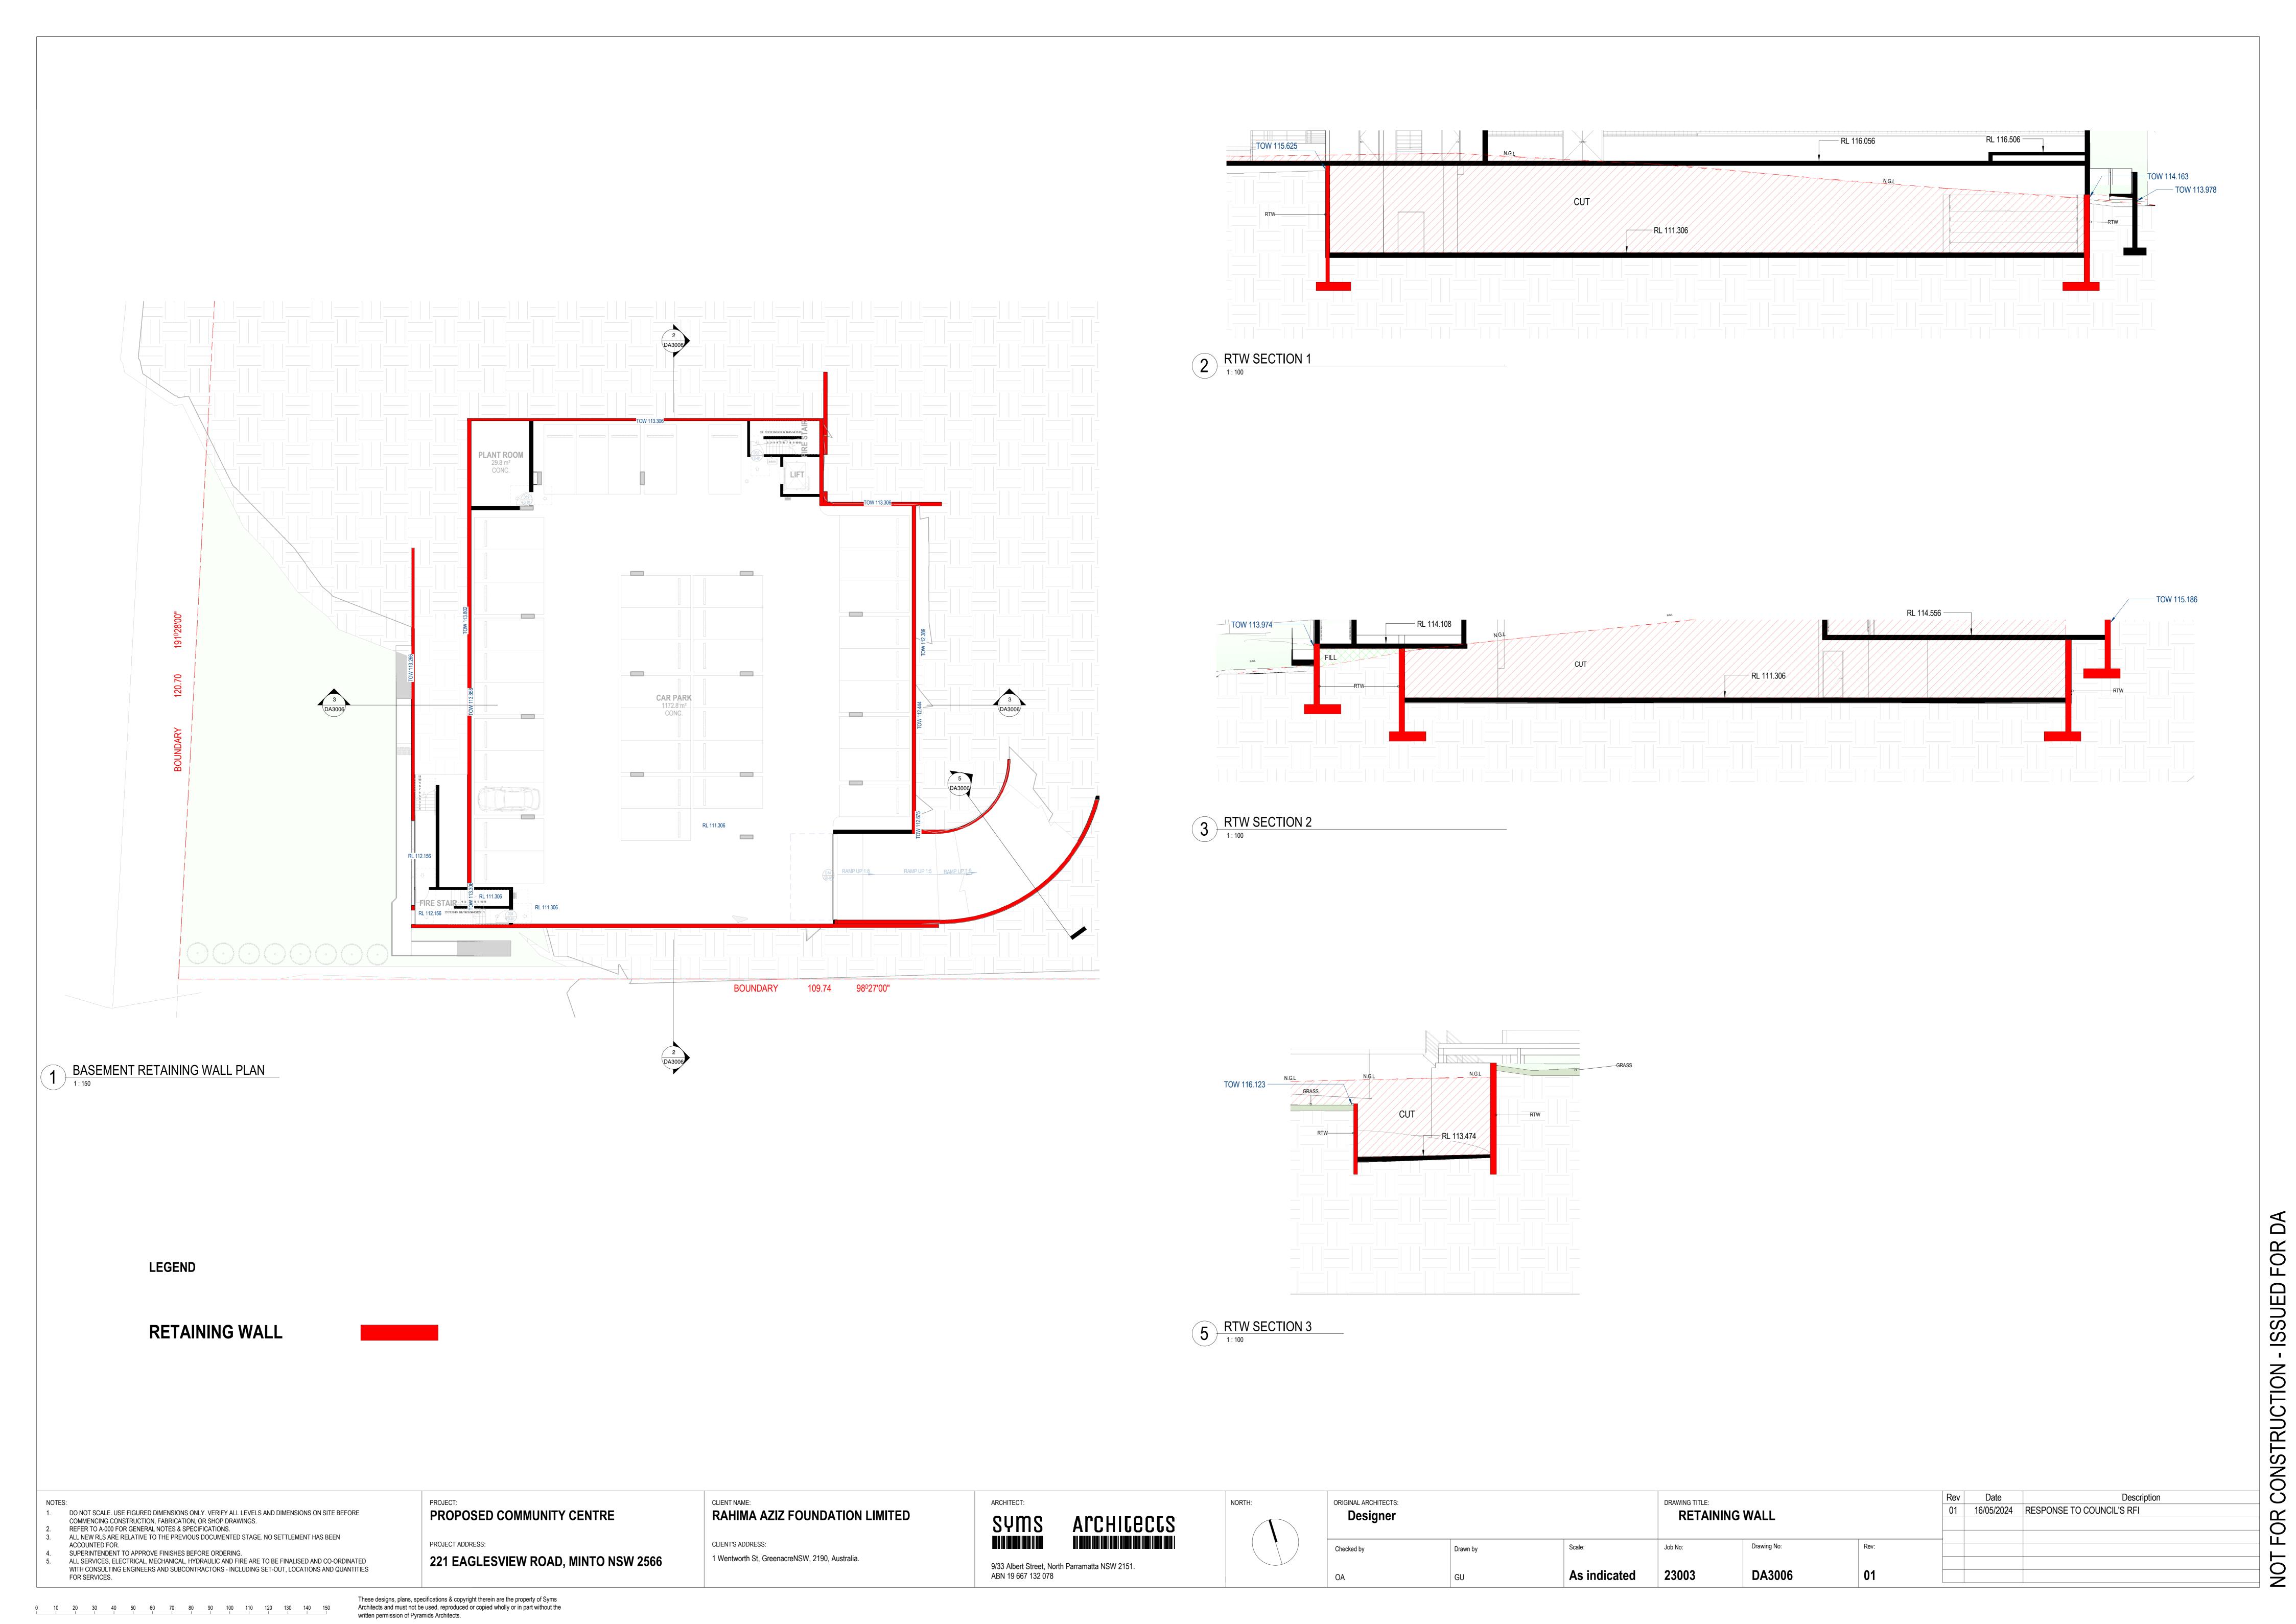
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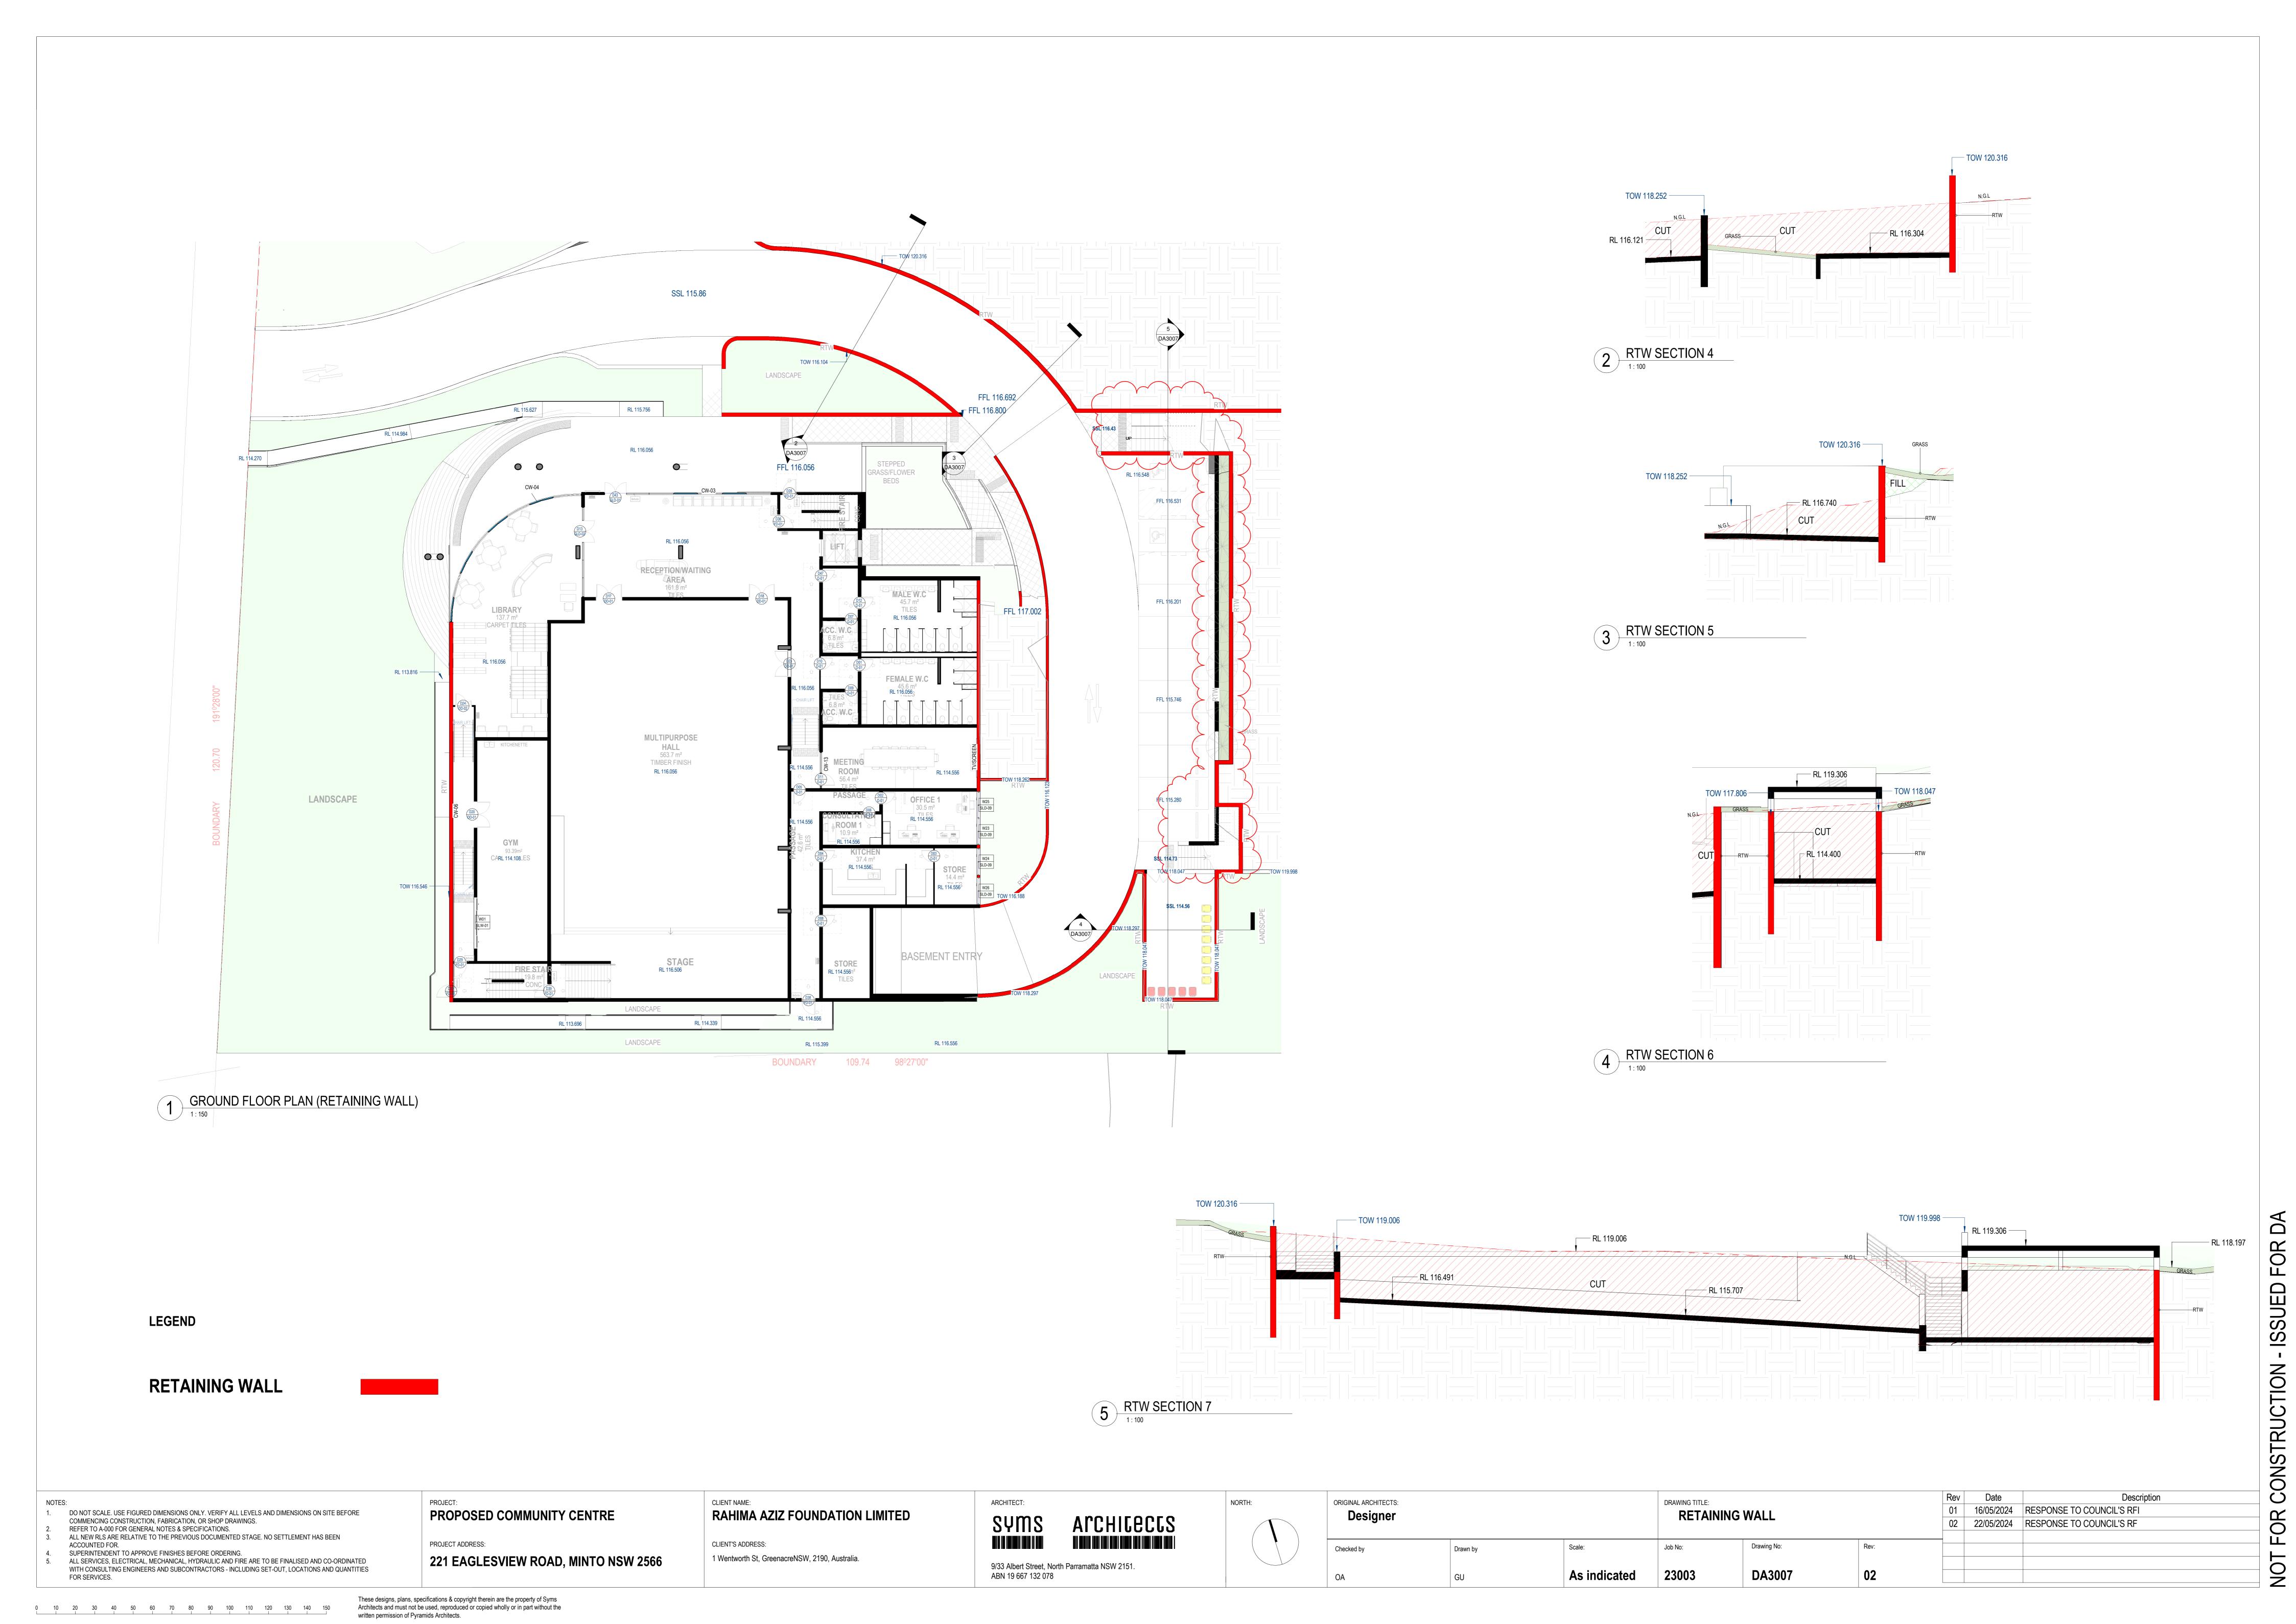
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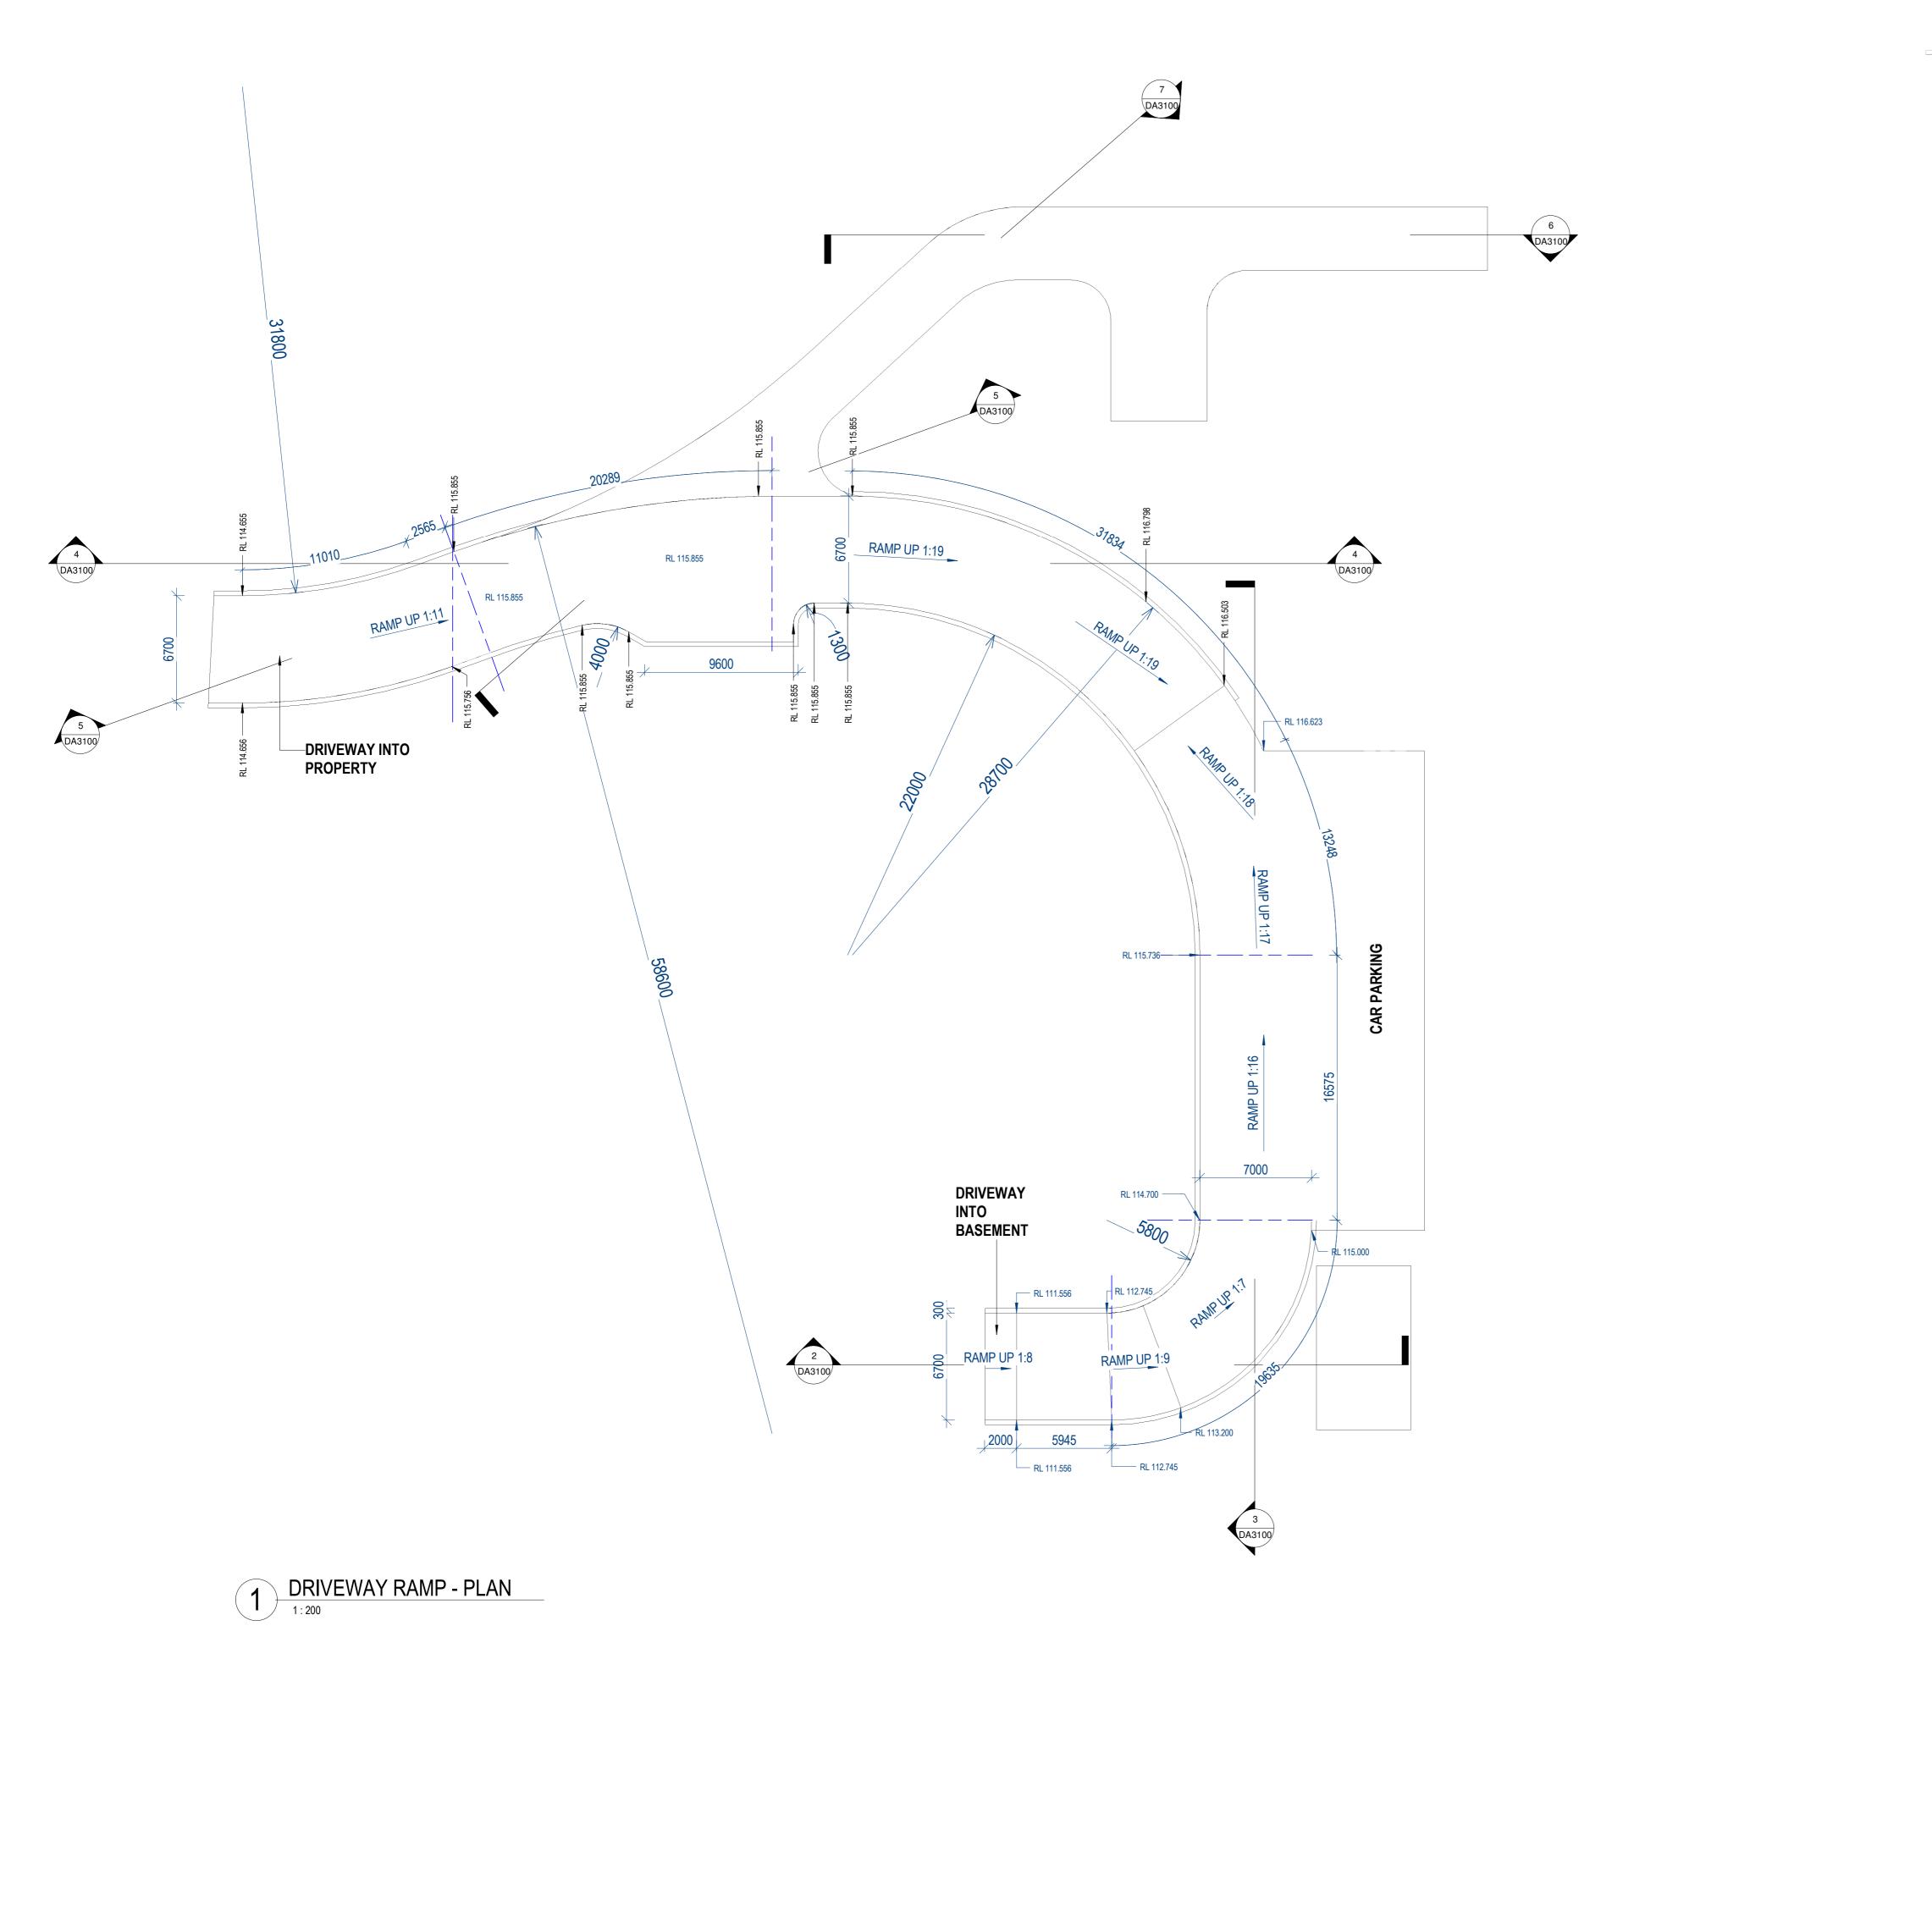
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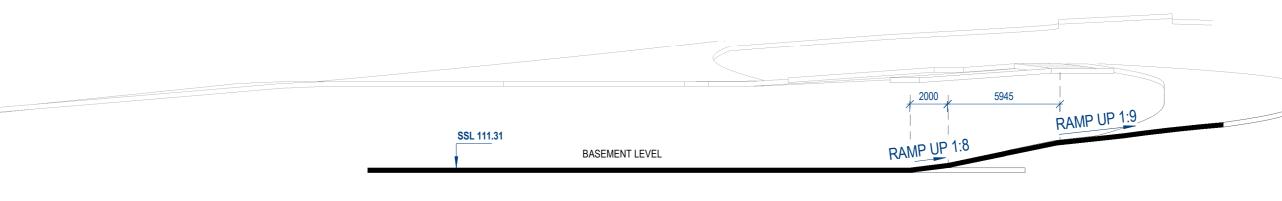
221 EAGLESVIEW ROAD, MINTO NSW 2566














2 DRIVEWAY SECTION 1

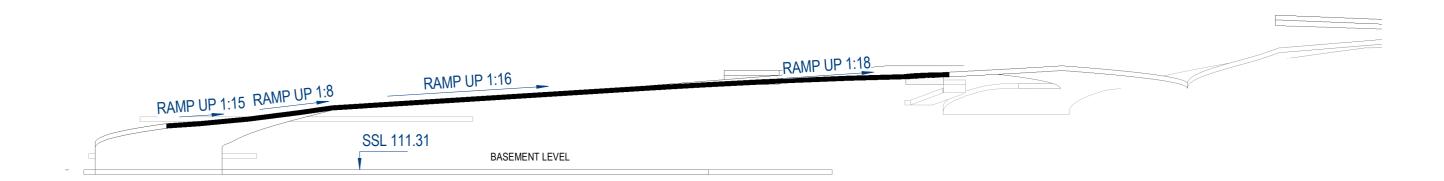


3 DRIVEWAY SECTION 2

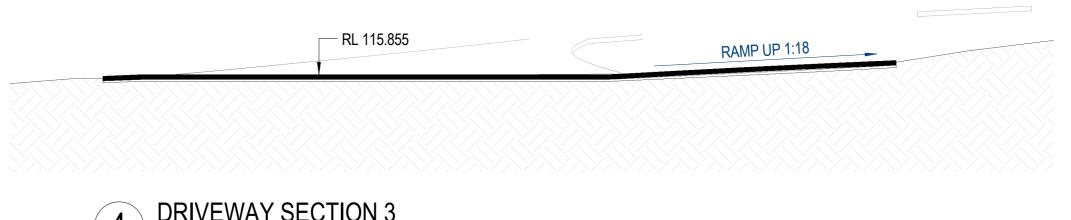


4 DRIVEWAY SECTION 3

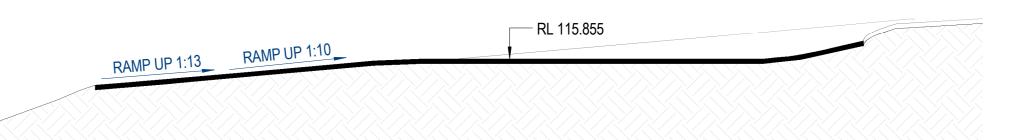

5 DRIVEWAY SECTION 4

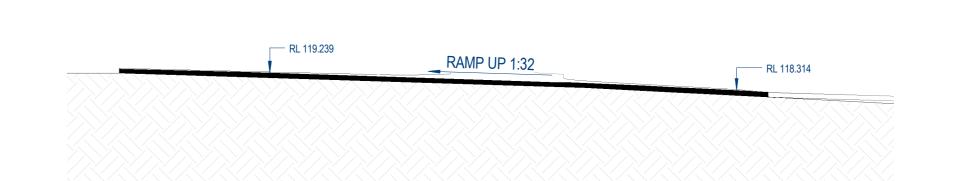


6 DRIVEWAY SECTION 5

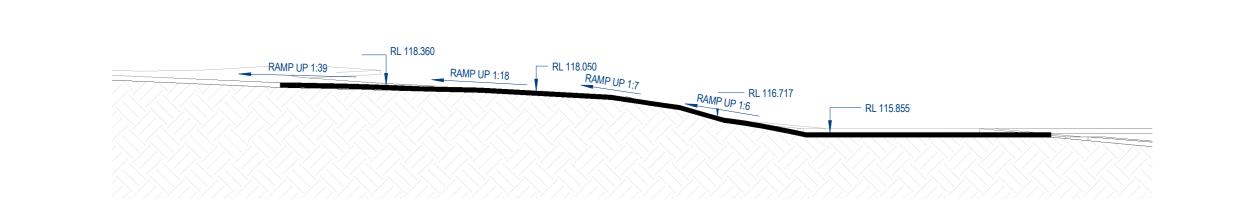



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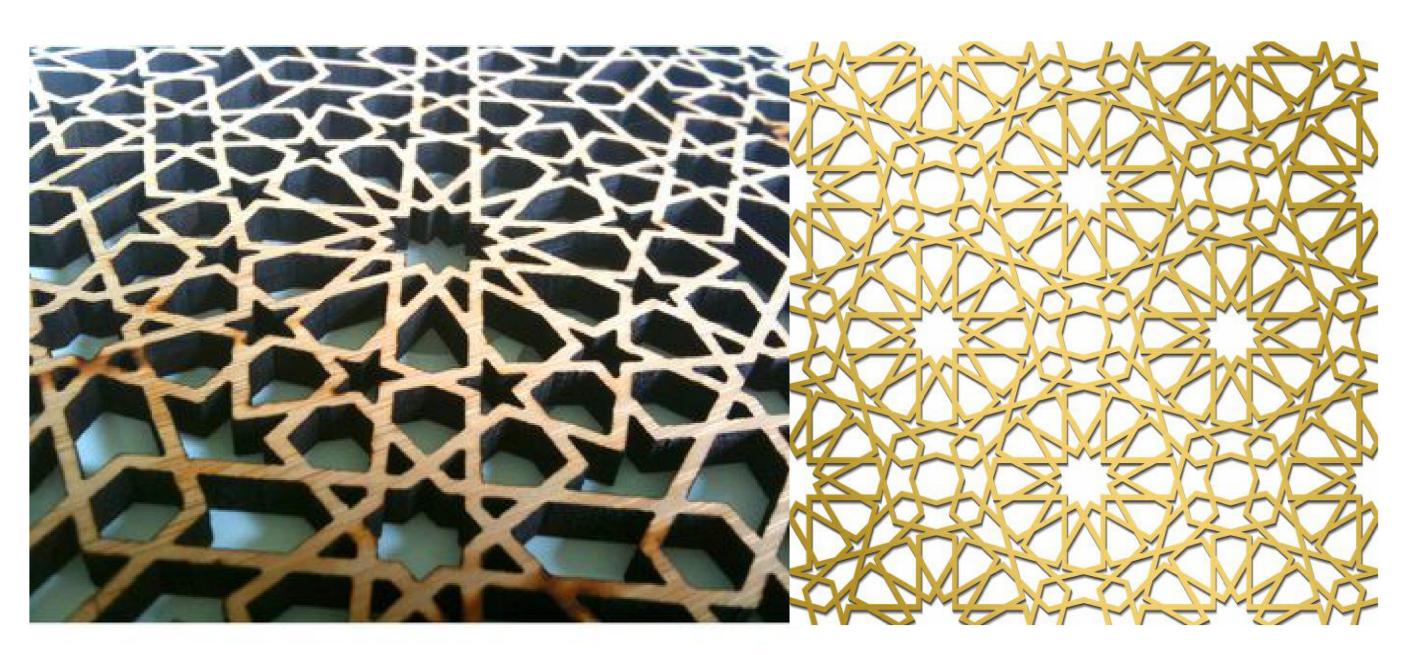
DRIVEWAY TO COMPLY WITH AS1428.1 AS REQUIRED

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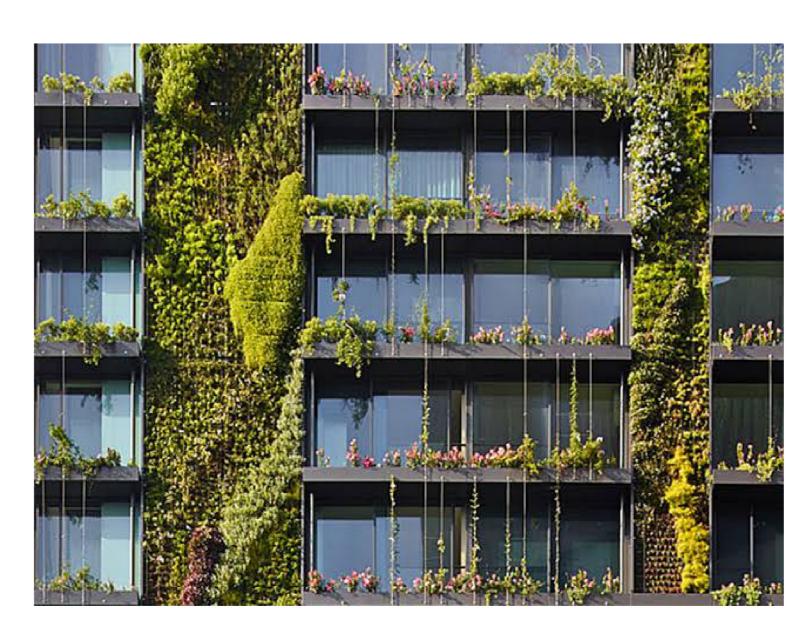




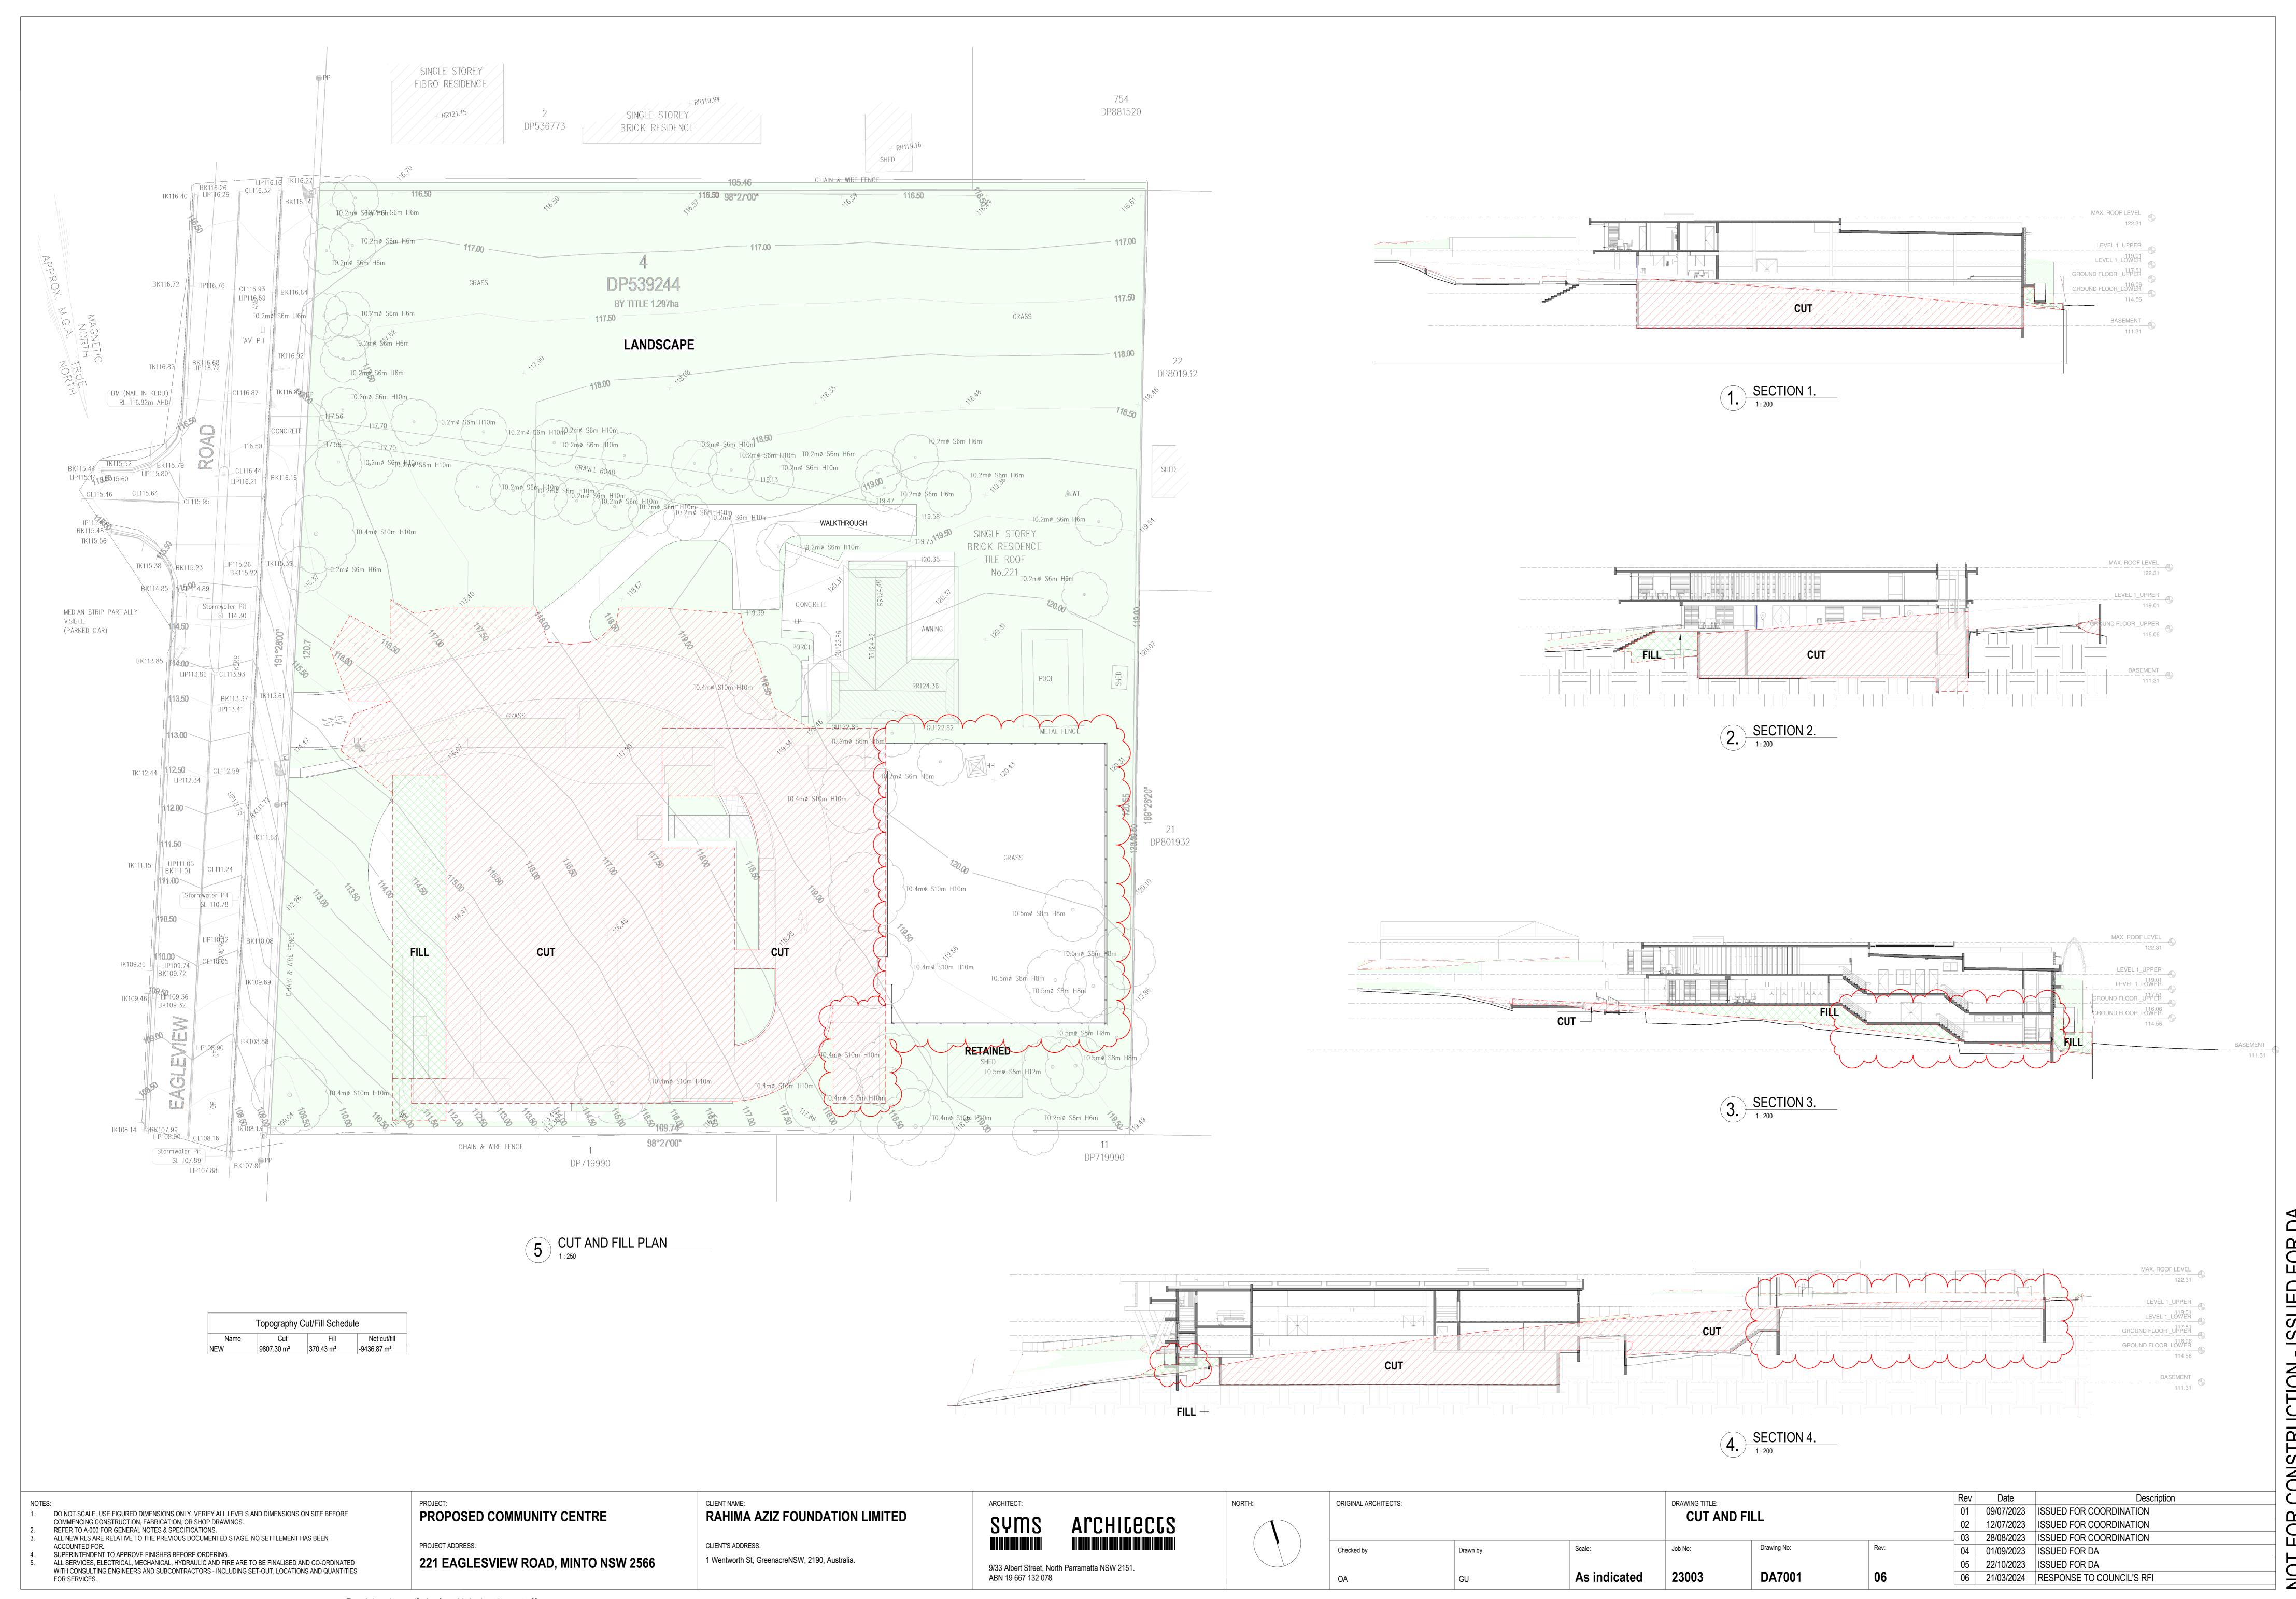

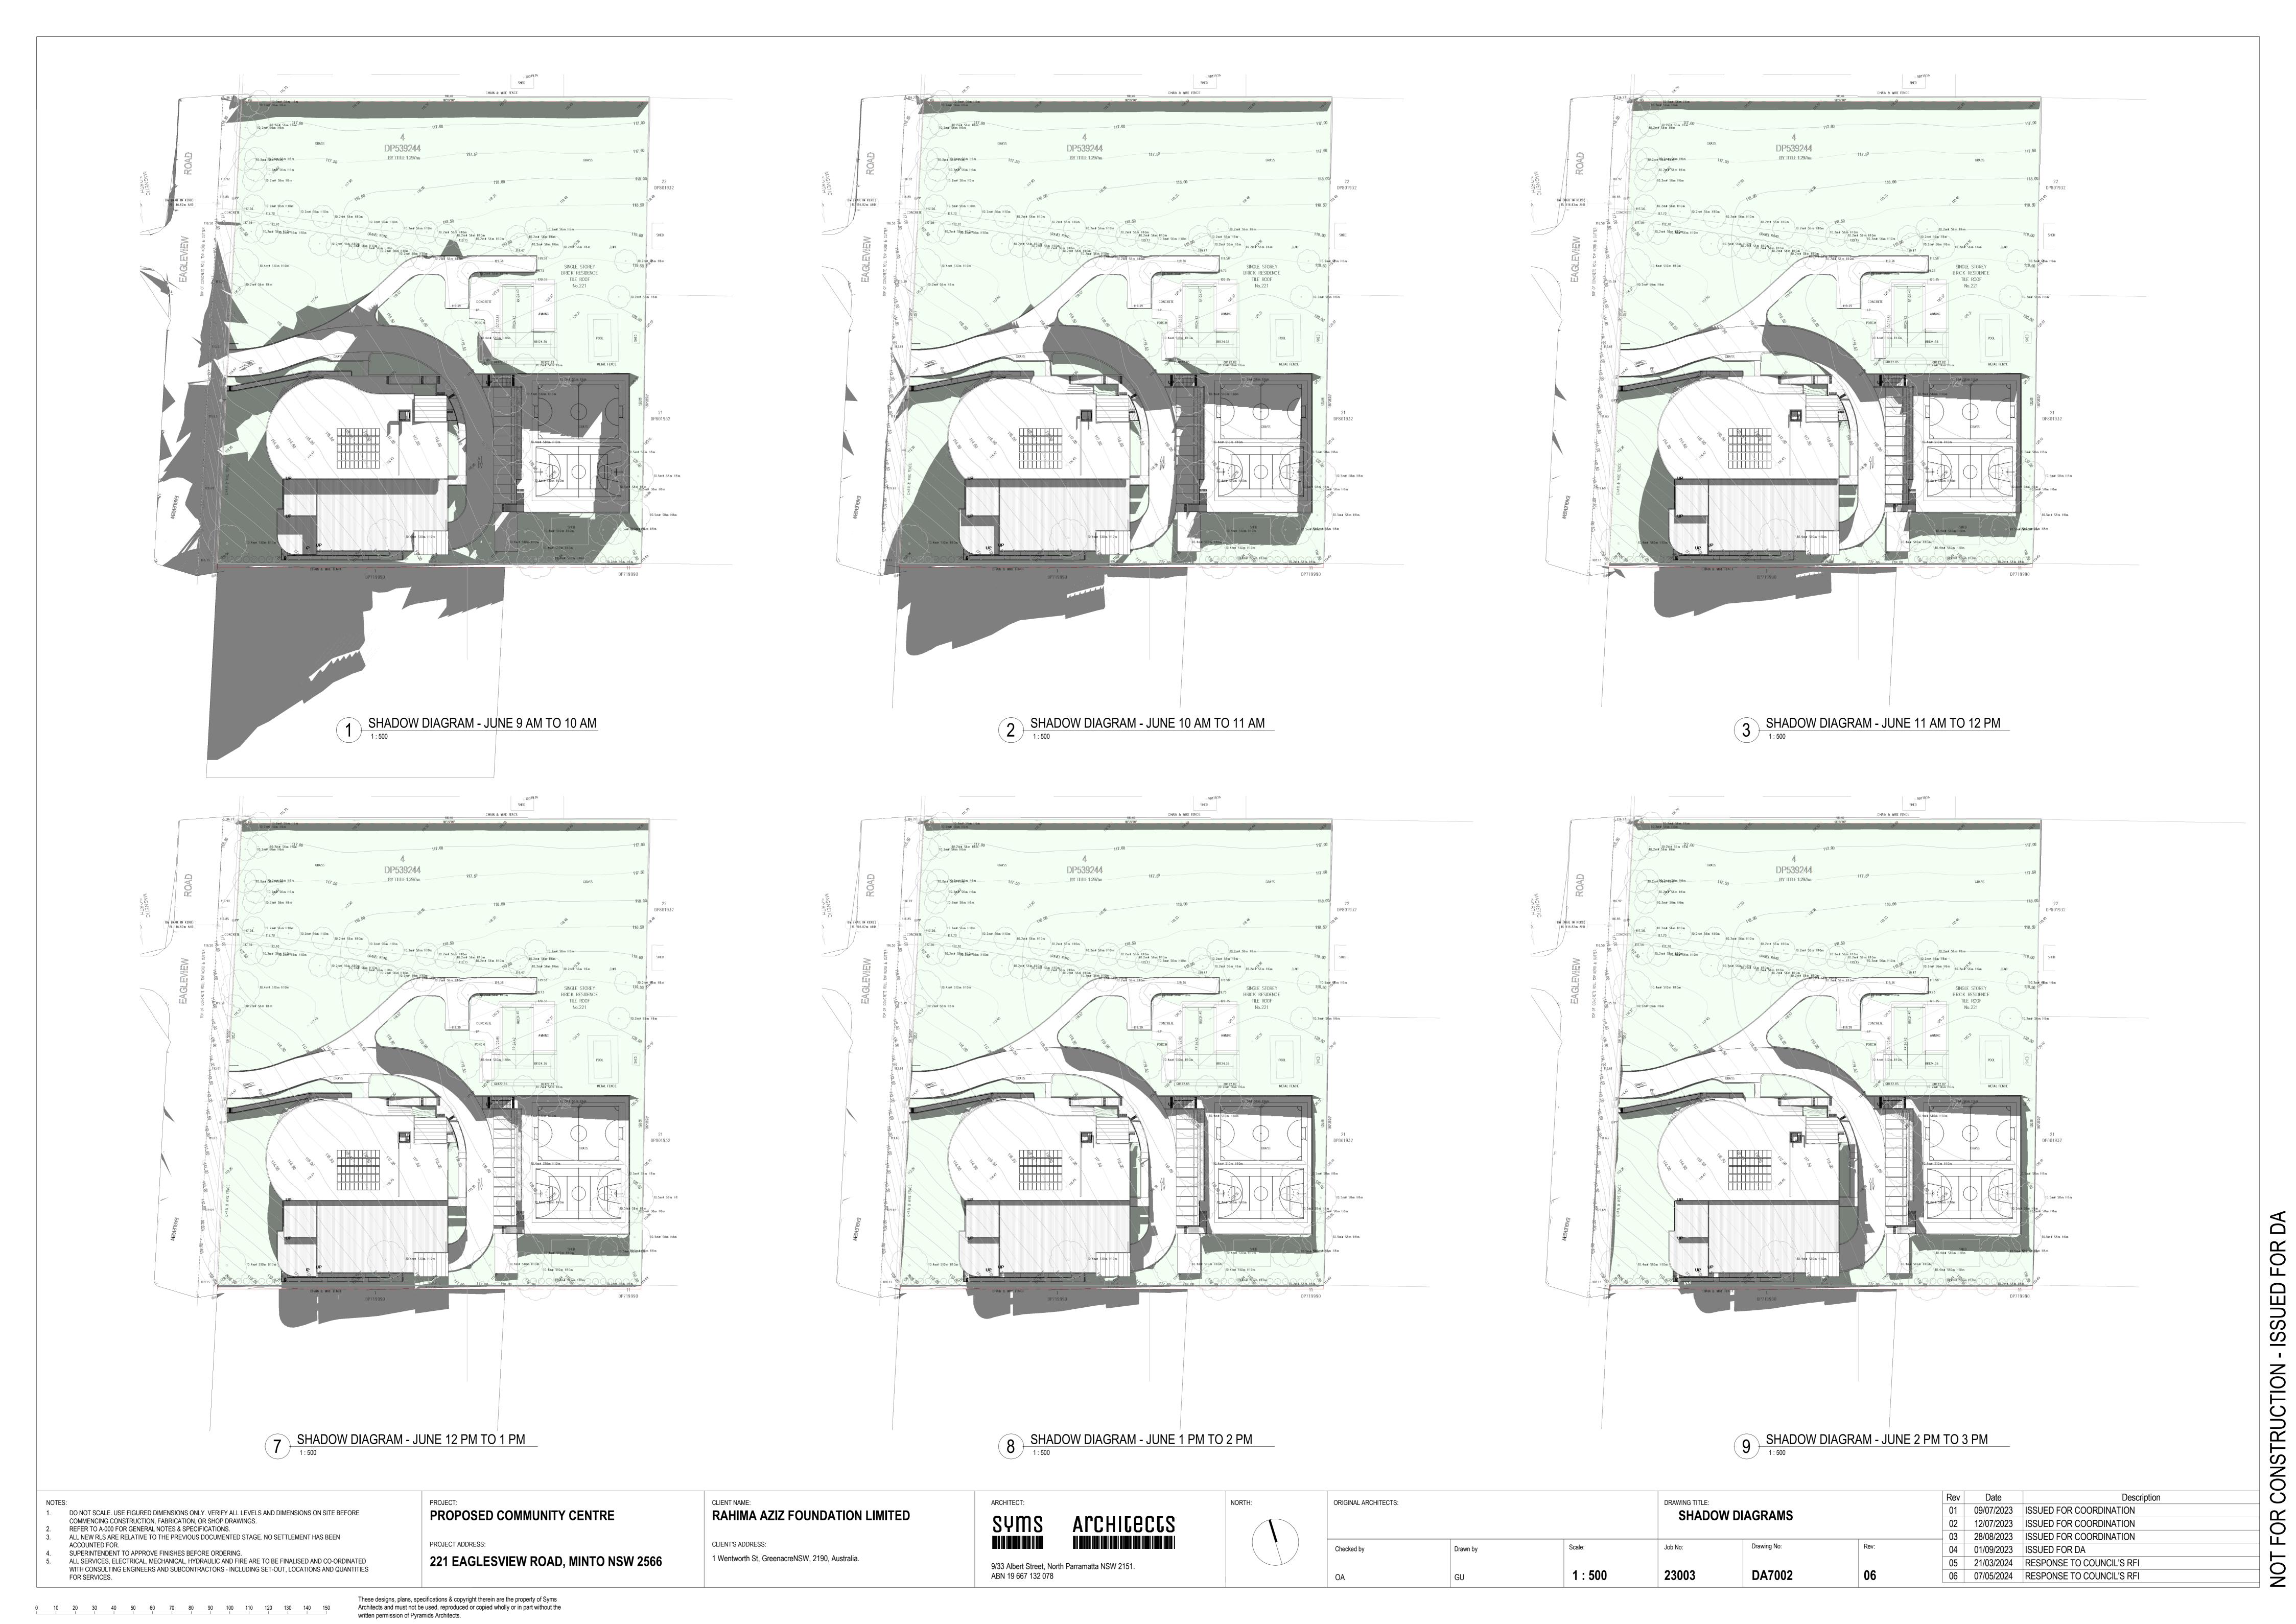

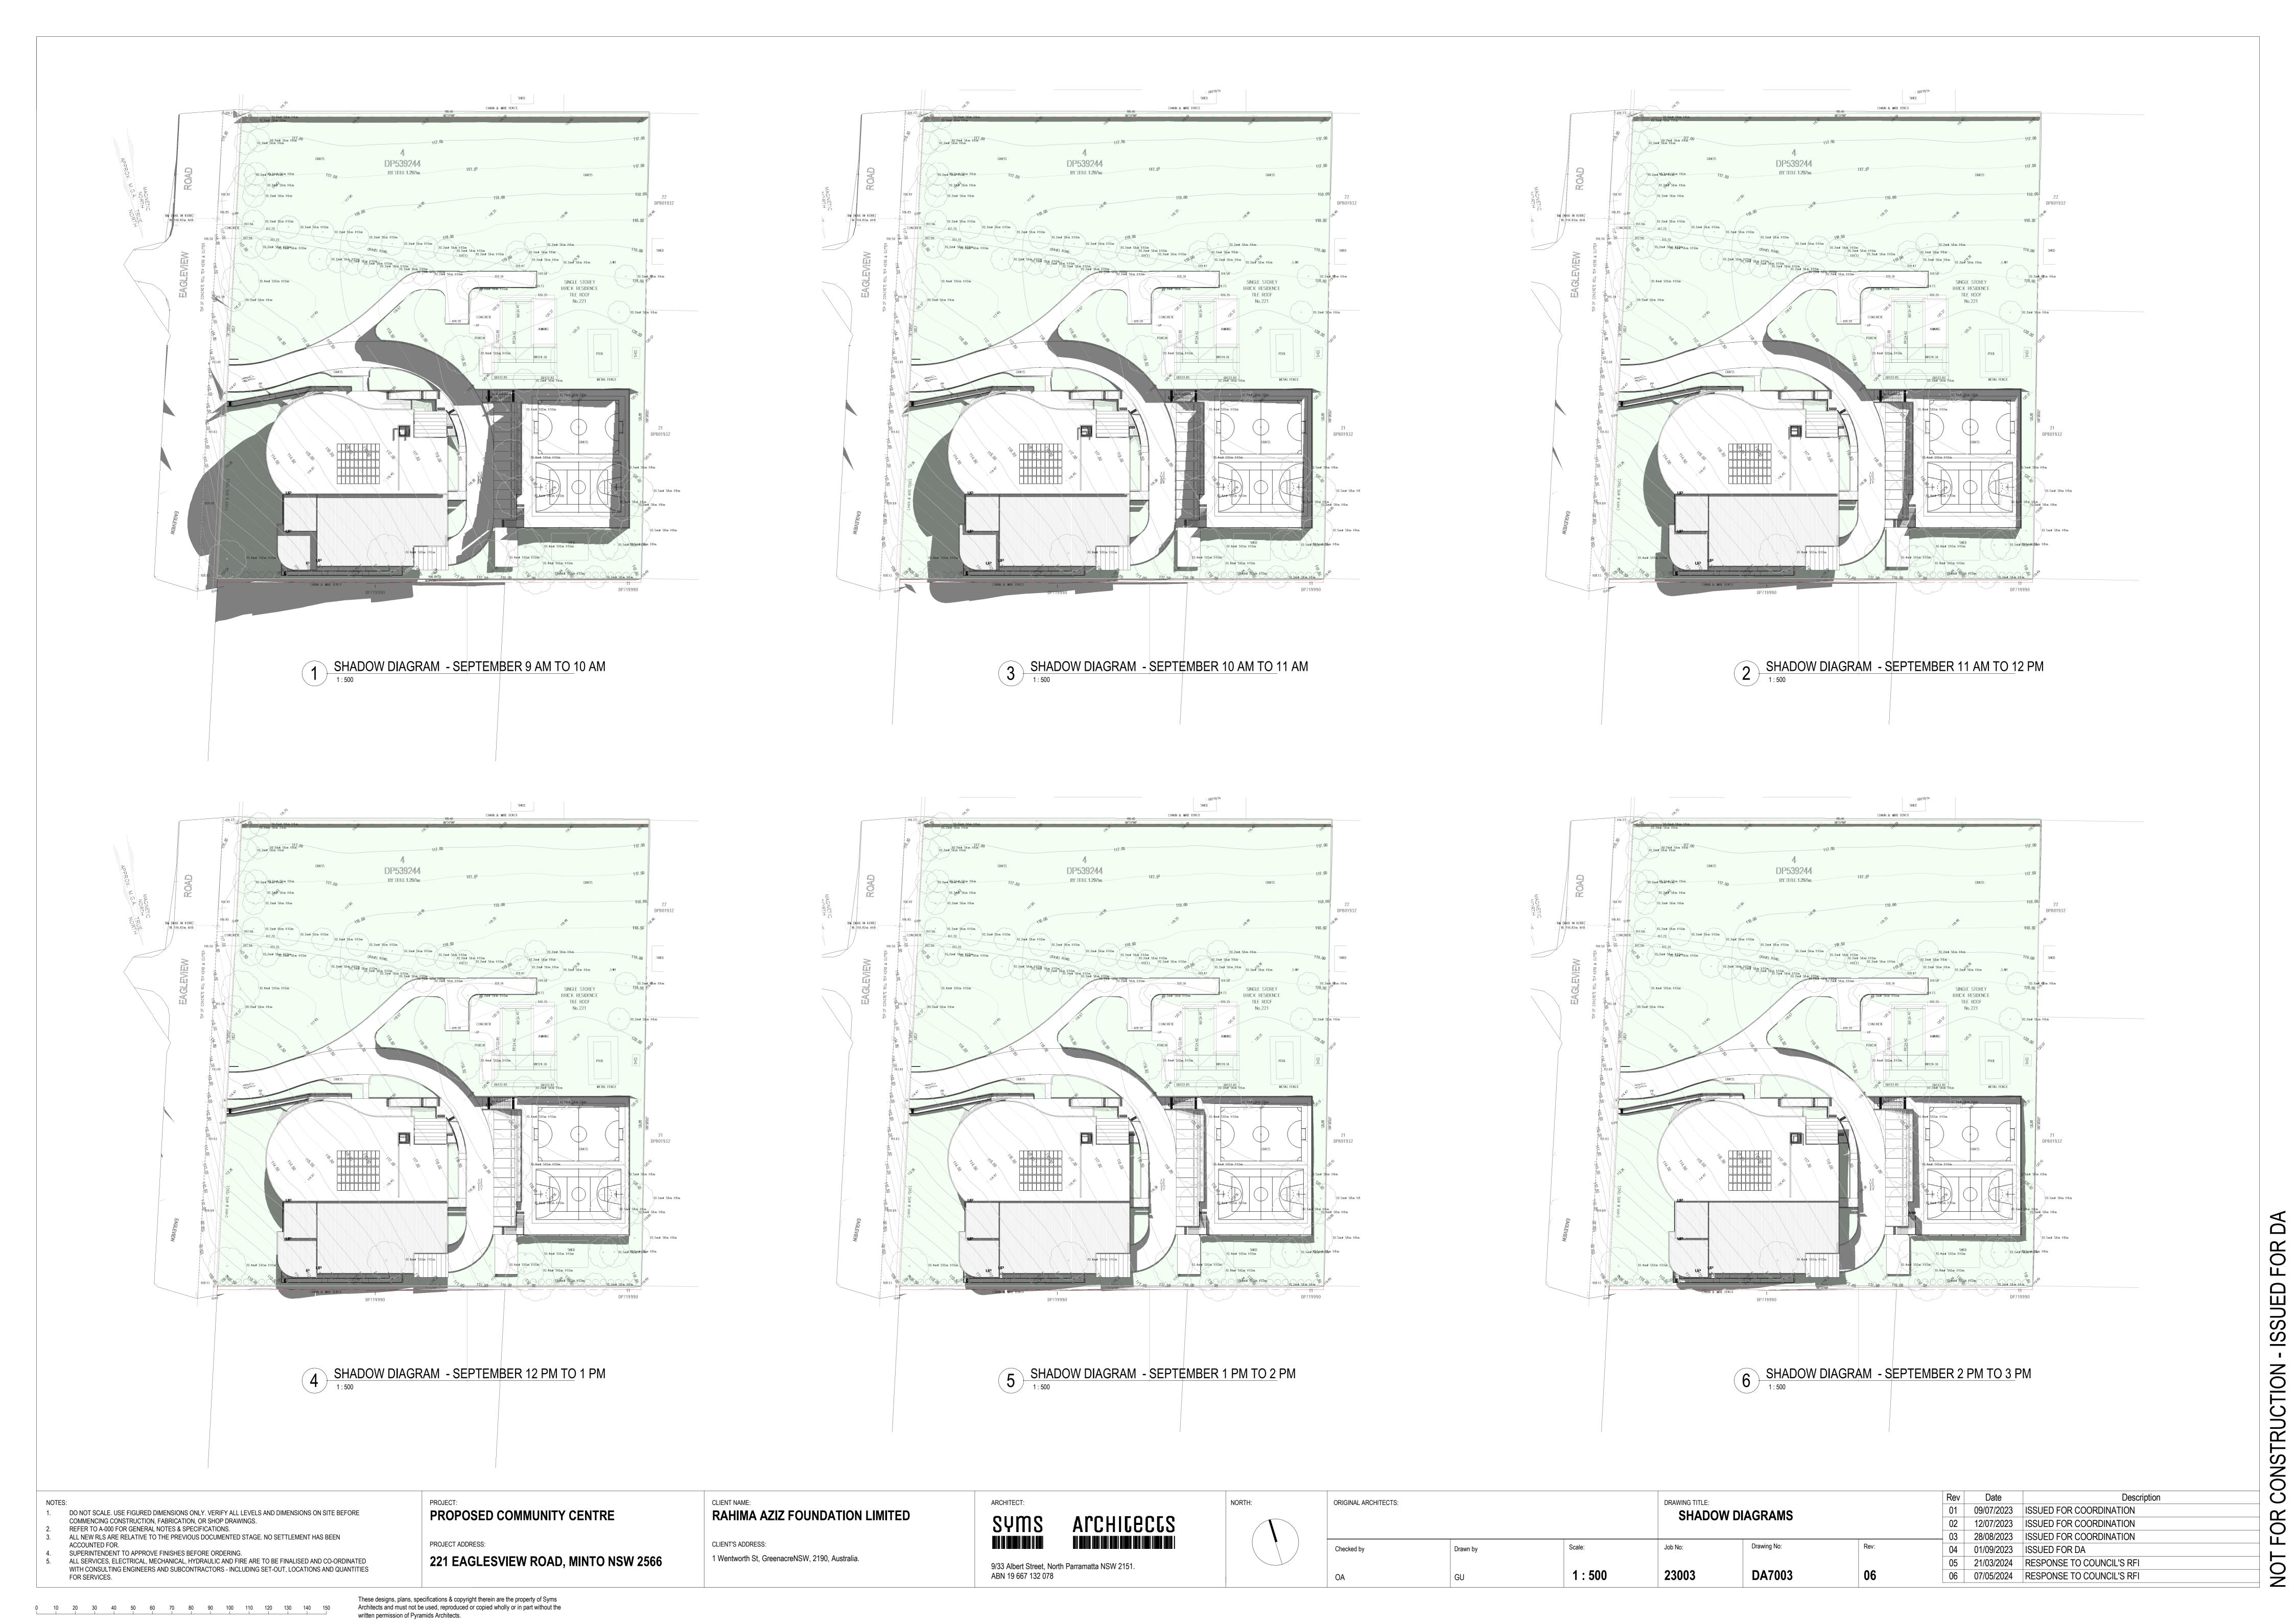ALUMINUM SCREEN FACADE (MS)
TURQUOISE COLOUR.



2. WALL PLANTS ON SOUTH-WALL



TURQUOISE COLOUR METAL SCREEN POWDERCOAT COLORBOND FINISH - MONUMENT- ALUMINIUM FRAMES DULUX ETERNITY - TITANIUM PEARL OR RENDERED WALL FACADE DULUX ETERNITY - CHAIN PEARL PARAPET FACADE POWDERCOAT FINISH VITRADUAL- SNOW WHITE-METAL SCREEN RENDERED FACADE

COLOUR CONCEPT ONLY, COLOUR TONES MAY VARY SLIGHTLY. FINAL COLOURS TO BE SIGNED OFF BY THE DESIGN ARCHITECT.

EXTERNAL FINISH COLOUR LEGEND

1: 150



RENDERED FACADE (RF) PAINTED DULUX ETERNITY CHAIN PEARL COLOUR.




4. LARGE FORMAT GLASS FACADE (GL).




ALUMINIUM FRAME ON WINDOWS AND DOORS -POWDERCOAT FINISH COLORBOND - MONUMENT.



6. ROLLER SHUTTER PAINTED IN MONUMENT GREY.

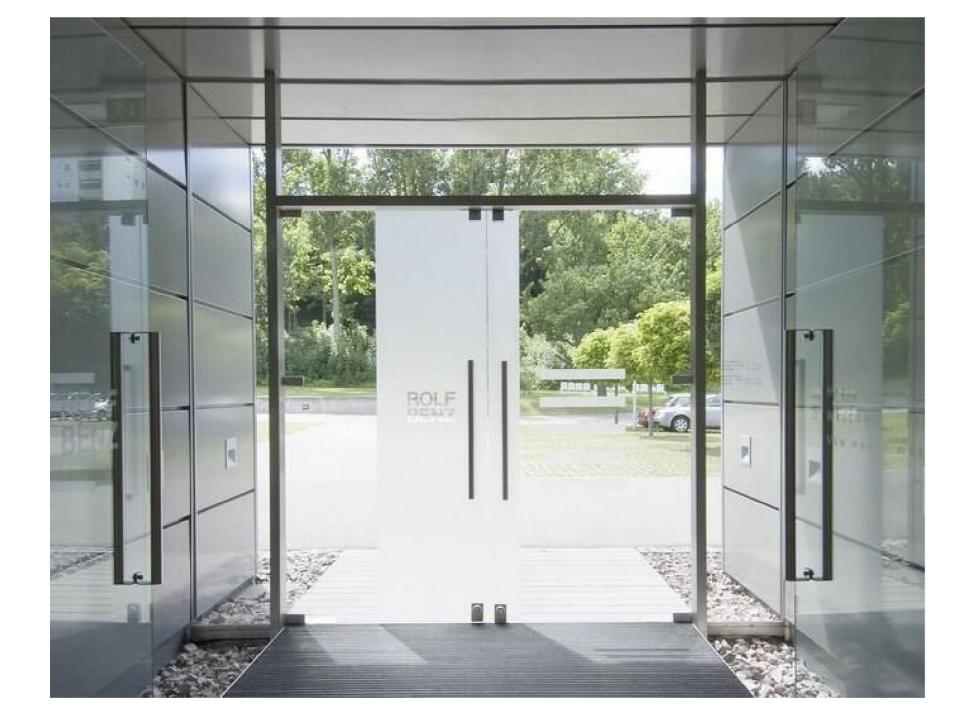

FRAMELESS GLASS DOOR.

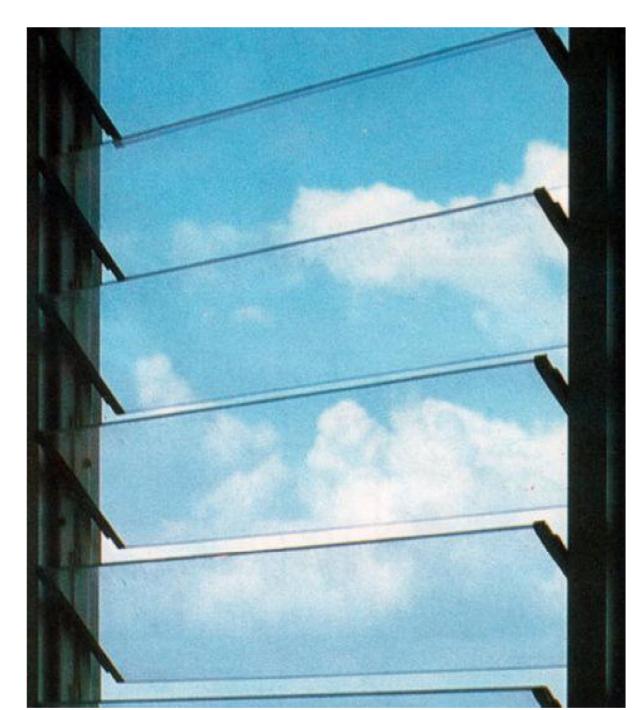


8. LOUVRE WINDOW (LV).

CLIENT'S ADDRESS:



NORTH:

8. TOP RAIL GLASS BALUSTRADE.

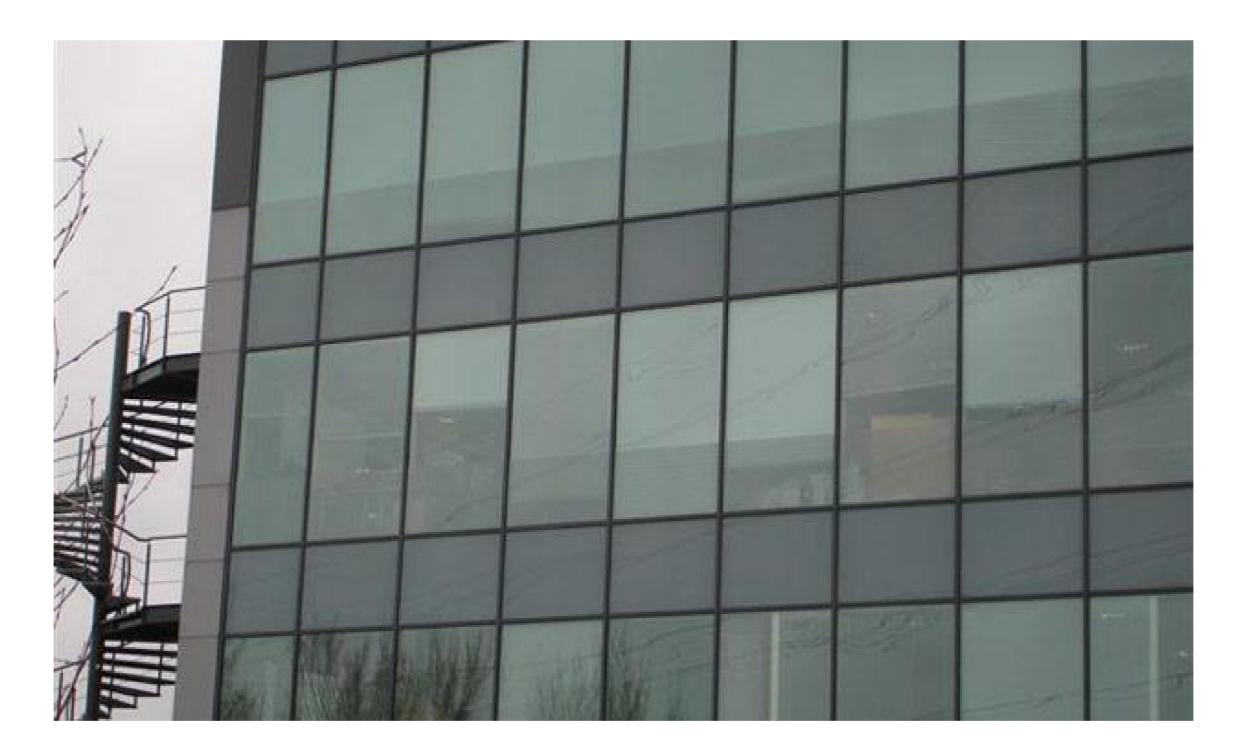

9. CURTAIN WALL SPANDREL.

FINISHES SCHEDULE
1:100

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FOR SERVICES.

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WITH CONSULTING ENGINEERS AND SUBCONTRACTORS - INCLUDING SET-OUT, LOCATIONS AND QUANTITIES

PROPOSED COMMUNITY CENTRE

221 EAGLESVIEW ROAD, MINTO NSW 2566

PROJECT ADDRESS:

RAHIMA AZIZ FOUNDATION LIMITED

1 Wentworth St, GreenacreNSW, 2190, Australia.

SYMS 9/33 Albert Street, North Parramatta NSW 2151.

ABN 19 667 132 078

ORIGINAL ARCHITECTS: Checked by As indicated

DRAWING TITLE: FINISHES SCHEDULE			Rev 01 02	Date 09/07/2023 12/07/2023	Description ISSUED FOR COORDINATION ISSUED FOR COORDINATION
			03	28/08/2023	ISSUED FOR COORDINATION
Job No:	Rev:	04	01/09/2023	ISSUED FOR DA	
			05	21/03/2024	RESPONSE TO COUNCIL'S RFI
23003	DA_FN	05			

PROPOSED COMMUNITY FACILITY AT: 221 EAGLEVIEW ROAD, MINTO, NSW 2566

STORMWATER DRAINAGE DRAWING PACKAGE

GENERAL NOTES

THIS PLAN IS A CONCEPT PLAN ONLY FOR STORMWATER DISPOSAL & EROSION CONTROL. IT IS NOT SUITABLE FOR CONSTRUCTION. THIS PLAN SHOULD BE ADAPTED BY THE BUILDER DURING DEMOLITION, EXCAVATION & CONSTRUCTION PHASES TO ENSURE ADEQUATE PERFORMANCE.

ALL DRAINAGE LAYOUT & DETAILS ARE DIAGRAMMATIC & INDICATIVE ONLY. ACTUAL LOCATION, SIZES, LEVELS & GRADES MAY ALTER WHEN DETAIL DESIGN WORKS ARE DOCUMENTED.

DRAINAGE NOTES:

ALL PIPES TO BE LAID ON 75mm SAND BED WITH THE BARRELS FULLY SUPPORTED

100mm AND 150mm DIAMETER PIPES TO BE LAID ON MINIMUM 1% GRADE

MINIMUM DEPTH OF COVER FOR PIPES NOT SUBJECT TO VEHICULAR LOADING TO BE 300mm

ALL DRAINAGE PIPES LAID UNDER PAVEMENT SHALL BE REINFORCED CONCRETE WITH RUBBER RING JOINTS

BACKFILL TRENCHES WITH COMPACTED SAND OR APPROVED AGGREGATE MATERIAL

ALL PITS TO HAVE 600x600mm INTERNAL DIMENSIONS (U.N.O.)

SILT ARRESTORS TO HAVE 900x900mm INTERNAL DIMENSIONS

HEAVY DUTY GRATES AND COVERS ARE TO BE PROVIDED IN TRAFFICABLE AREAS

PIT GRATE TO BE TYPE WELDLOK OR APPROVED EQUIVALENT

ALL PITS SHALL BE PROVIDED WITH A LOCKING CLIP

ALL PITS SHALL BE MAINTAINED REGULARLY

TOP OF BENCHING SHALL BE TO THE HALF OF THE OUTLET PIPE DIAMETER

MAXIMUM FRONT ENTRY PIPE: -STRAIGHT ENTRY - Ø750 SKEW ENTRY 45° - Ø525

Ø100 SUBSOIL DRAINAGE PIPE 3000mm LONG WRAPPED IN FABRIC SOCK TO BE PROVIDED ADJACENT TO INLET PIPES

COMPRESSIVE STRENGTH f'o FOR CAST IN SITU CONCRETE TO BE A MINIMUM OF 20MPa AT 28 DAYS

PROVIDE CLEANING EYES TO ALL DOWNPIPES NOT DIRECTLY CONNECTED TO PITS ISOLATED JOINTS TO BE PROVIDED TO ISOLATE CONCRETE PAVEMENTS FROM

ALL TRENCH GRATES PROVIDED SHALL HAVE A MINIMUM CLEAR WIDTH OF

STORMWATER DRAINAGE CONNECTIONS TO THE MAIN SYSTEM SHALL BE TO THE REQUIREMENTS AND THE SATISFACTION OF LOCAL COUNCIL



DRAWING REGISTER											
NUMBER	REVISION										
SW01	COVER SHEET	06									
SW02	EROSION & SEDIMENT CONTROL PLAN	06									
SW03	BASEMENT DRAINAGE PLAN	06									
SW04	ROOF/SITE DRAINAGE PLAN	06									
SW05	MUSIC MODEL RESULTS BY OCEAN PROTECT	06									
	MUSIC MODEL — WSUD SITE AREA BREAK—UP										
	OCEAN PROTECT — OCEANGUARD										
	OCEAN PROTECT — 9 CARTRIDGE STORMFILTER SYSTEM										
SD-S10	MINOR DRAINAGE CONNECTION — CAMPBELLTOWN CITY COUNCIL	VER2007									

EROSION & SEDIMENTATION

CONTRACTOR SHALL PROVIDE SEDIMENT FENCING MATERIAL DURING CONSTRUCTION TO THE LOW SIDE OF THE WORKS. TIE SEDIMENT FENCING MATERIAL TO CYCLONE WIRE SECURITY FENCE. SEDIMENT CONTROL FABRIC SHALL BE AN APPROVED MATERIAL (EG. HUMES PROPEX SILT STOP) STANDING 300mm ABOVE GROUND & EXTENDING 150mm BELOW GROUND.

EXISTING DRAINS LOCATED WITHIN THE SITE SHALL ALSO BE ISOLATED BY SEDIMENT FENCING MATERIAL.

NO PARKING OR STOCKPILING OF MATERIALS IS PERMITTED ON THE LOWER SIDE OF THE SEDIMENT FENCE.

GRASS VERGES SHALL BE MAINTAINED AS MUCH AS PRACTICAL TO PROVIDE A BUFFER ZONE TO THE CONSTRUCTION SITE.

CONSTRUCTION ENTRY/EXIT SHALL BE VIA THE LOCATION NOTED ON THE DRAWING. CONTRACTOR SHALL ENSURE ALL DROPPABLE SOIL & SEDIMENT IS REMOVED PRIOR TO CONSTRUCTION TRAFFIC EXITING SITE. CONTRACTOR SHALL ENSURE ALL CONSTRUCTION TRAFFIC ENTERING & LEAVING THE SITE DO SO IN A FORWARD DIRECTION.

AUTHORITY STORMWATER NOTES:

IT IS THE CONTRACTOR'S RESPONSIBILITY TO CHECK ALL SET OUT AND LEVELS PRIOR TO COMMENCEMENT OF WORKS AND TO REPORT ANY DISCREPANCIES FOUND TO THE SUPERINTENDANT.

ALL SET OUT DIMENSIONS ARE TO FACE OF KERB, CENTERLINE OF FENCE/BOLARD/PIPE.

SMOOTH ALL TRANSITIONS BETWEEN NEW AND EXISTING WORK IN BOTH LEVEL AND ALIGNMENT.

IT IS THE CONTRACTOR'S RESPONSIBILITY TO PROVIDE ALL SAFETY FENCES, WARNING SIGNS, TRAFFIC DIVERSIONS AND THE LIKE DURING CONSTRUCTION. ALL WORKS TO COMPLY WITH OCCUPATIONAL HEALTH AND SAFETY REQUIREMENTS AND OTHER RELEVANT AUTHORITY SAFETY REQUIREMENTS.

NO TREES SHALL BE REMOVED, CUTBACK OR RELOCATED WITHOUT THE WRITTEN INSTRUCTION FROM THE SUPERINTENDENT.

THE CONTRACTOR SHALL PROVIDE CERTIFICATION OF COMPACTION AND PAVEMENT THICKNESS FROM A NATA REGISTERED TESTING AUTHORITY. MINIMUM THREE TESTS PER LAYER AS FOLLOWS

PIPE BACKFILL SELECT FILL

DENSITY INDEX 75 95% STANDARD SELECT FILL (LESS THAN 300mm 98% MODIFIED

BELOW BASE COURSE) BASE COURSE

100% MODIFIED

THE AUSPEC SPECIFICATION SHALL BE THE SPECIFICATION FOR THESE WORKS.

Designed by:	E.C.
Drawn by:	A.A.
Revision:	06

ERTAZ H, CHOWDHURY MIEAust., CPEng. NER, Reg. No. 2214897

Australiawide Consulting Services P/L

Civil & Structural Engineering and Project Management 1369B Canterbury Rd, Punchbowl, NSW 2196 Mobile: 0420710548 Email: ertaz1@hotmail.com




9/33 Albert Street, North Parramatta NSW 2151.

Architects

RAHIMA AZIZ CHARITABLE ORGANISATION LIMITED

Client:

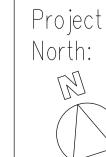

Project: PROPOSED COMMUNITY FACILITY AT 221 EAGLEVIEW ROAD, MINTO, NSW 2566

STORMWATER MANAGEMENT DRAWING PACKAGE FOR DA


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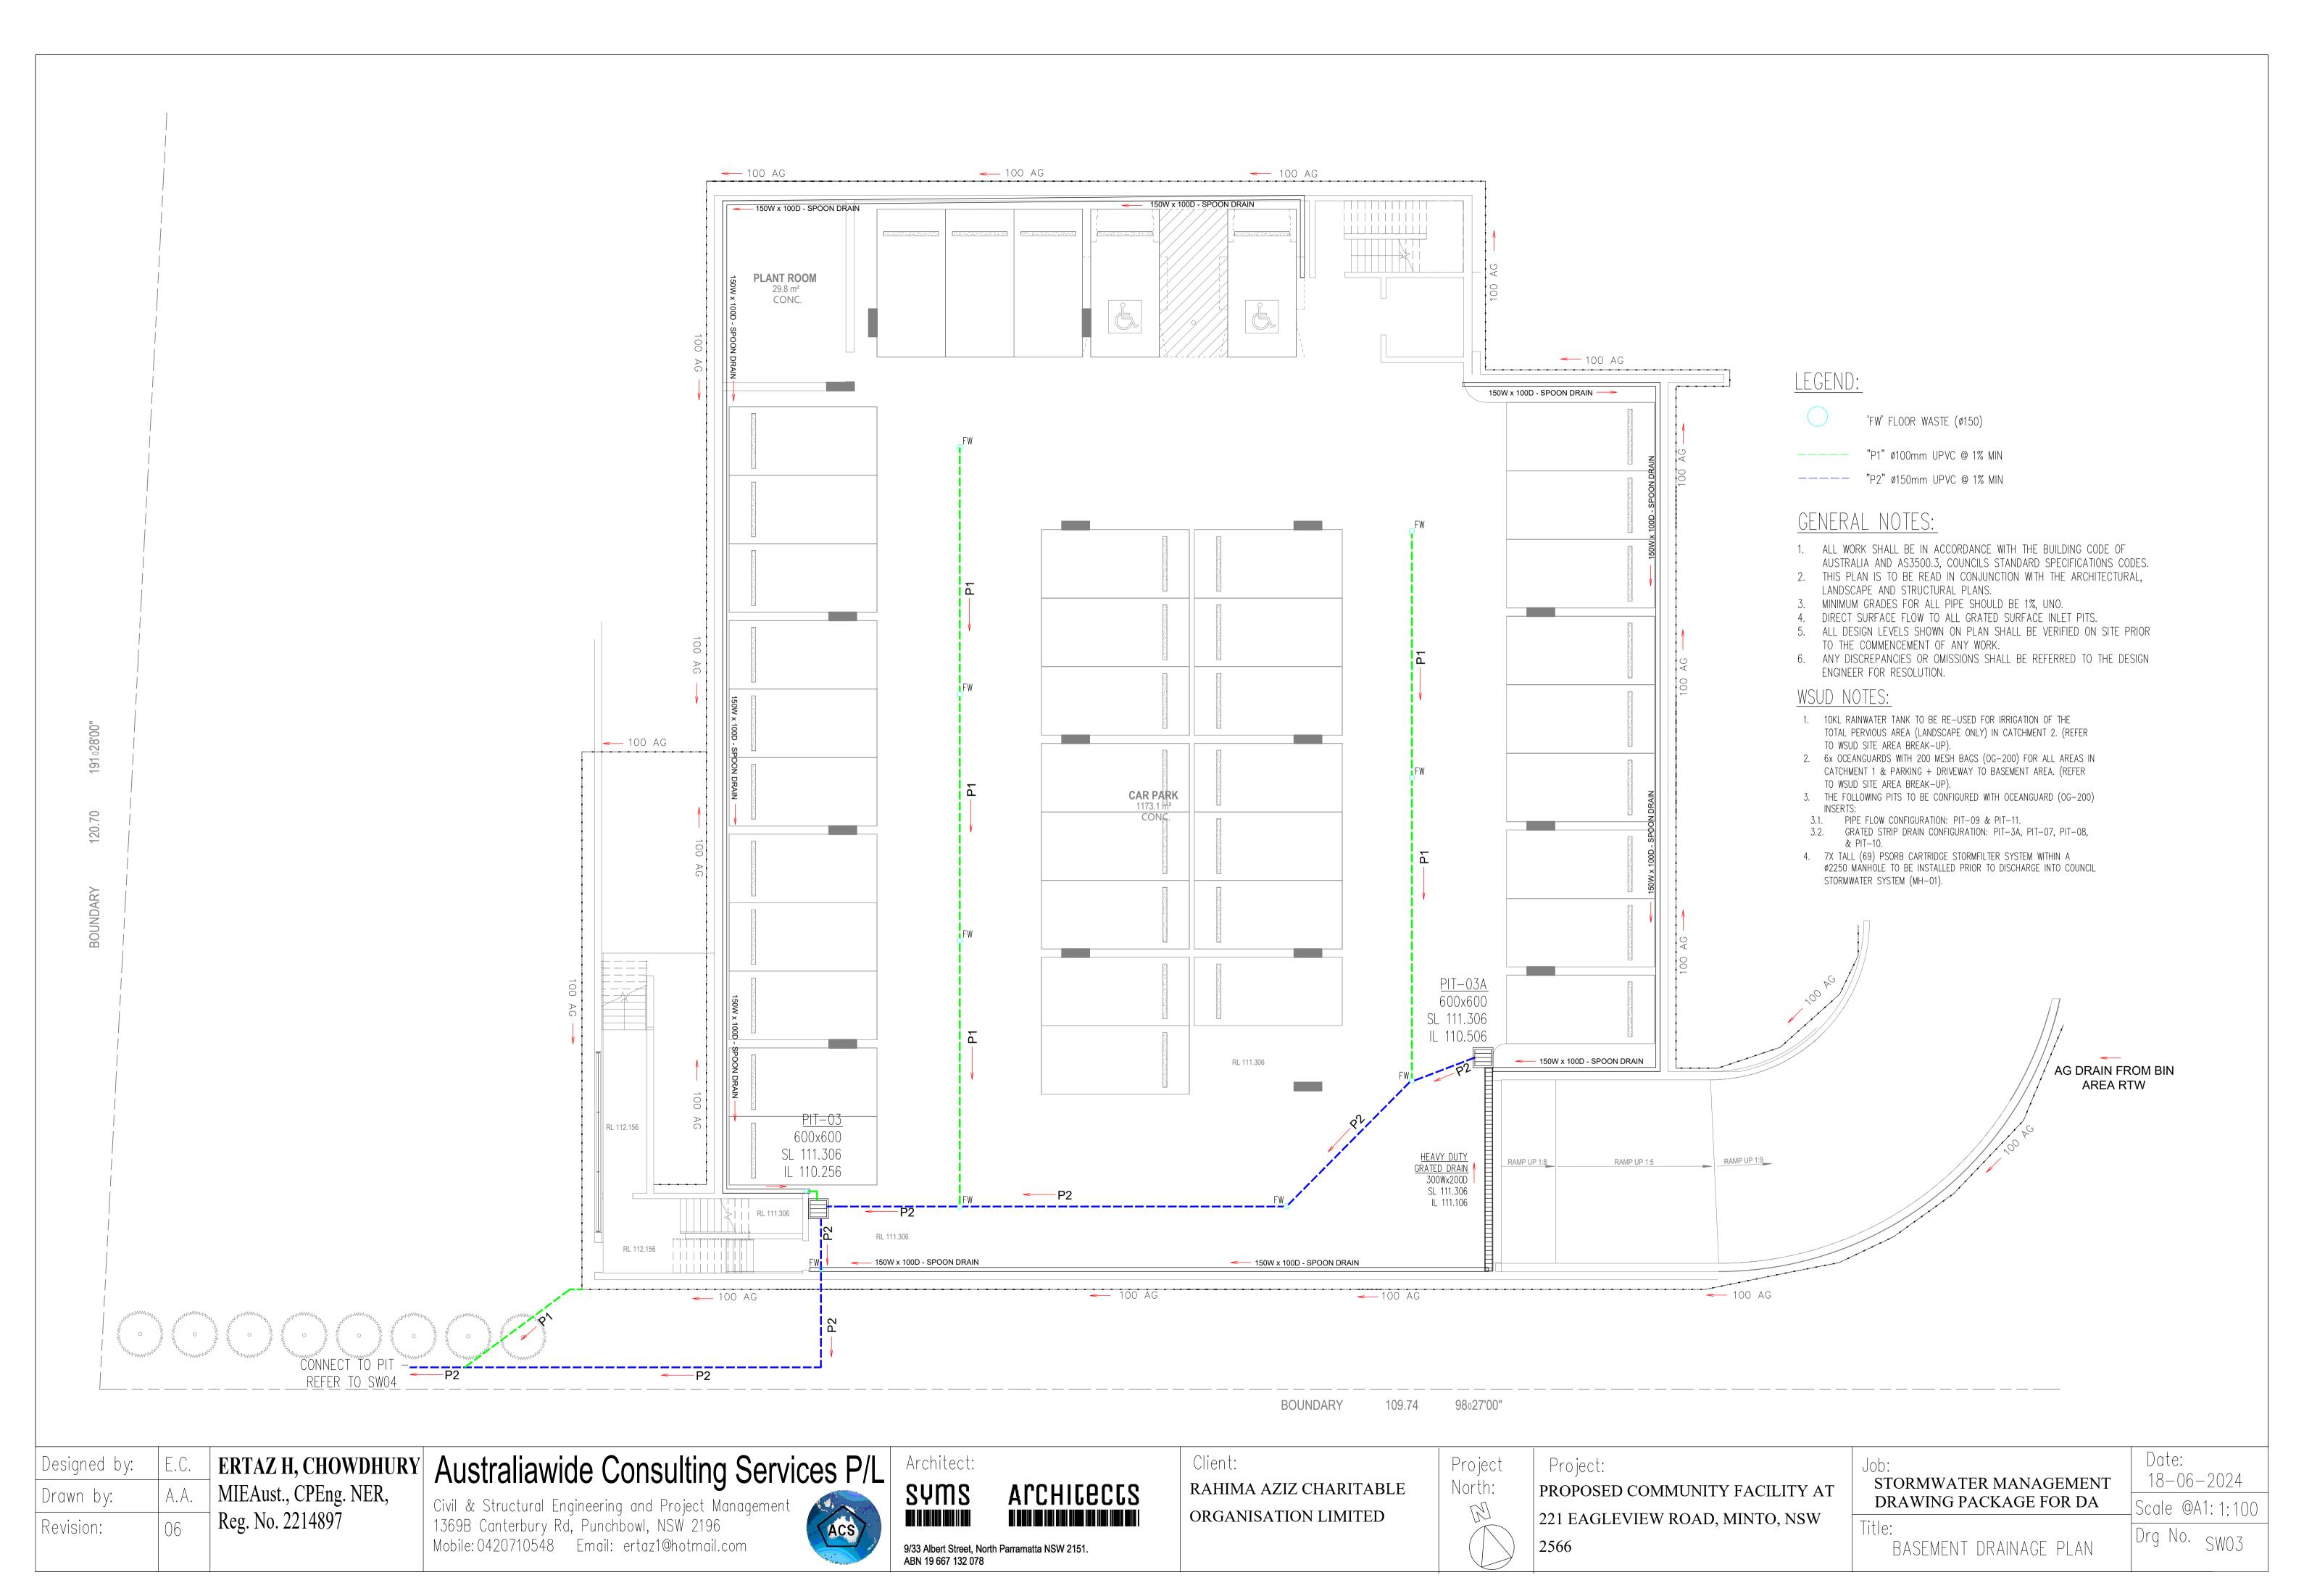
COVER SHEET


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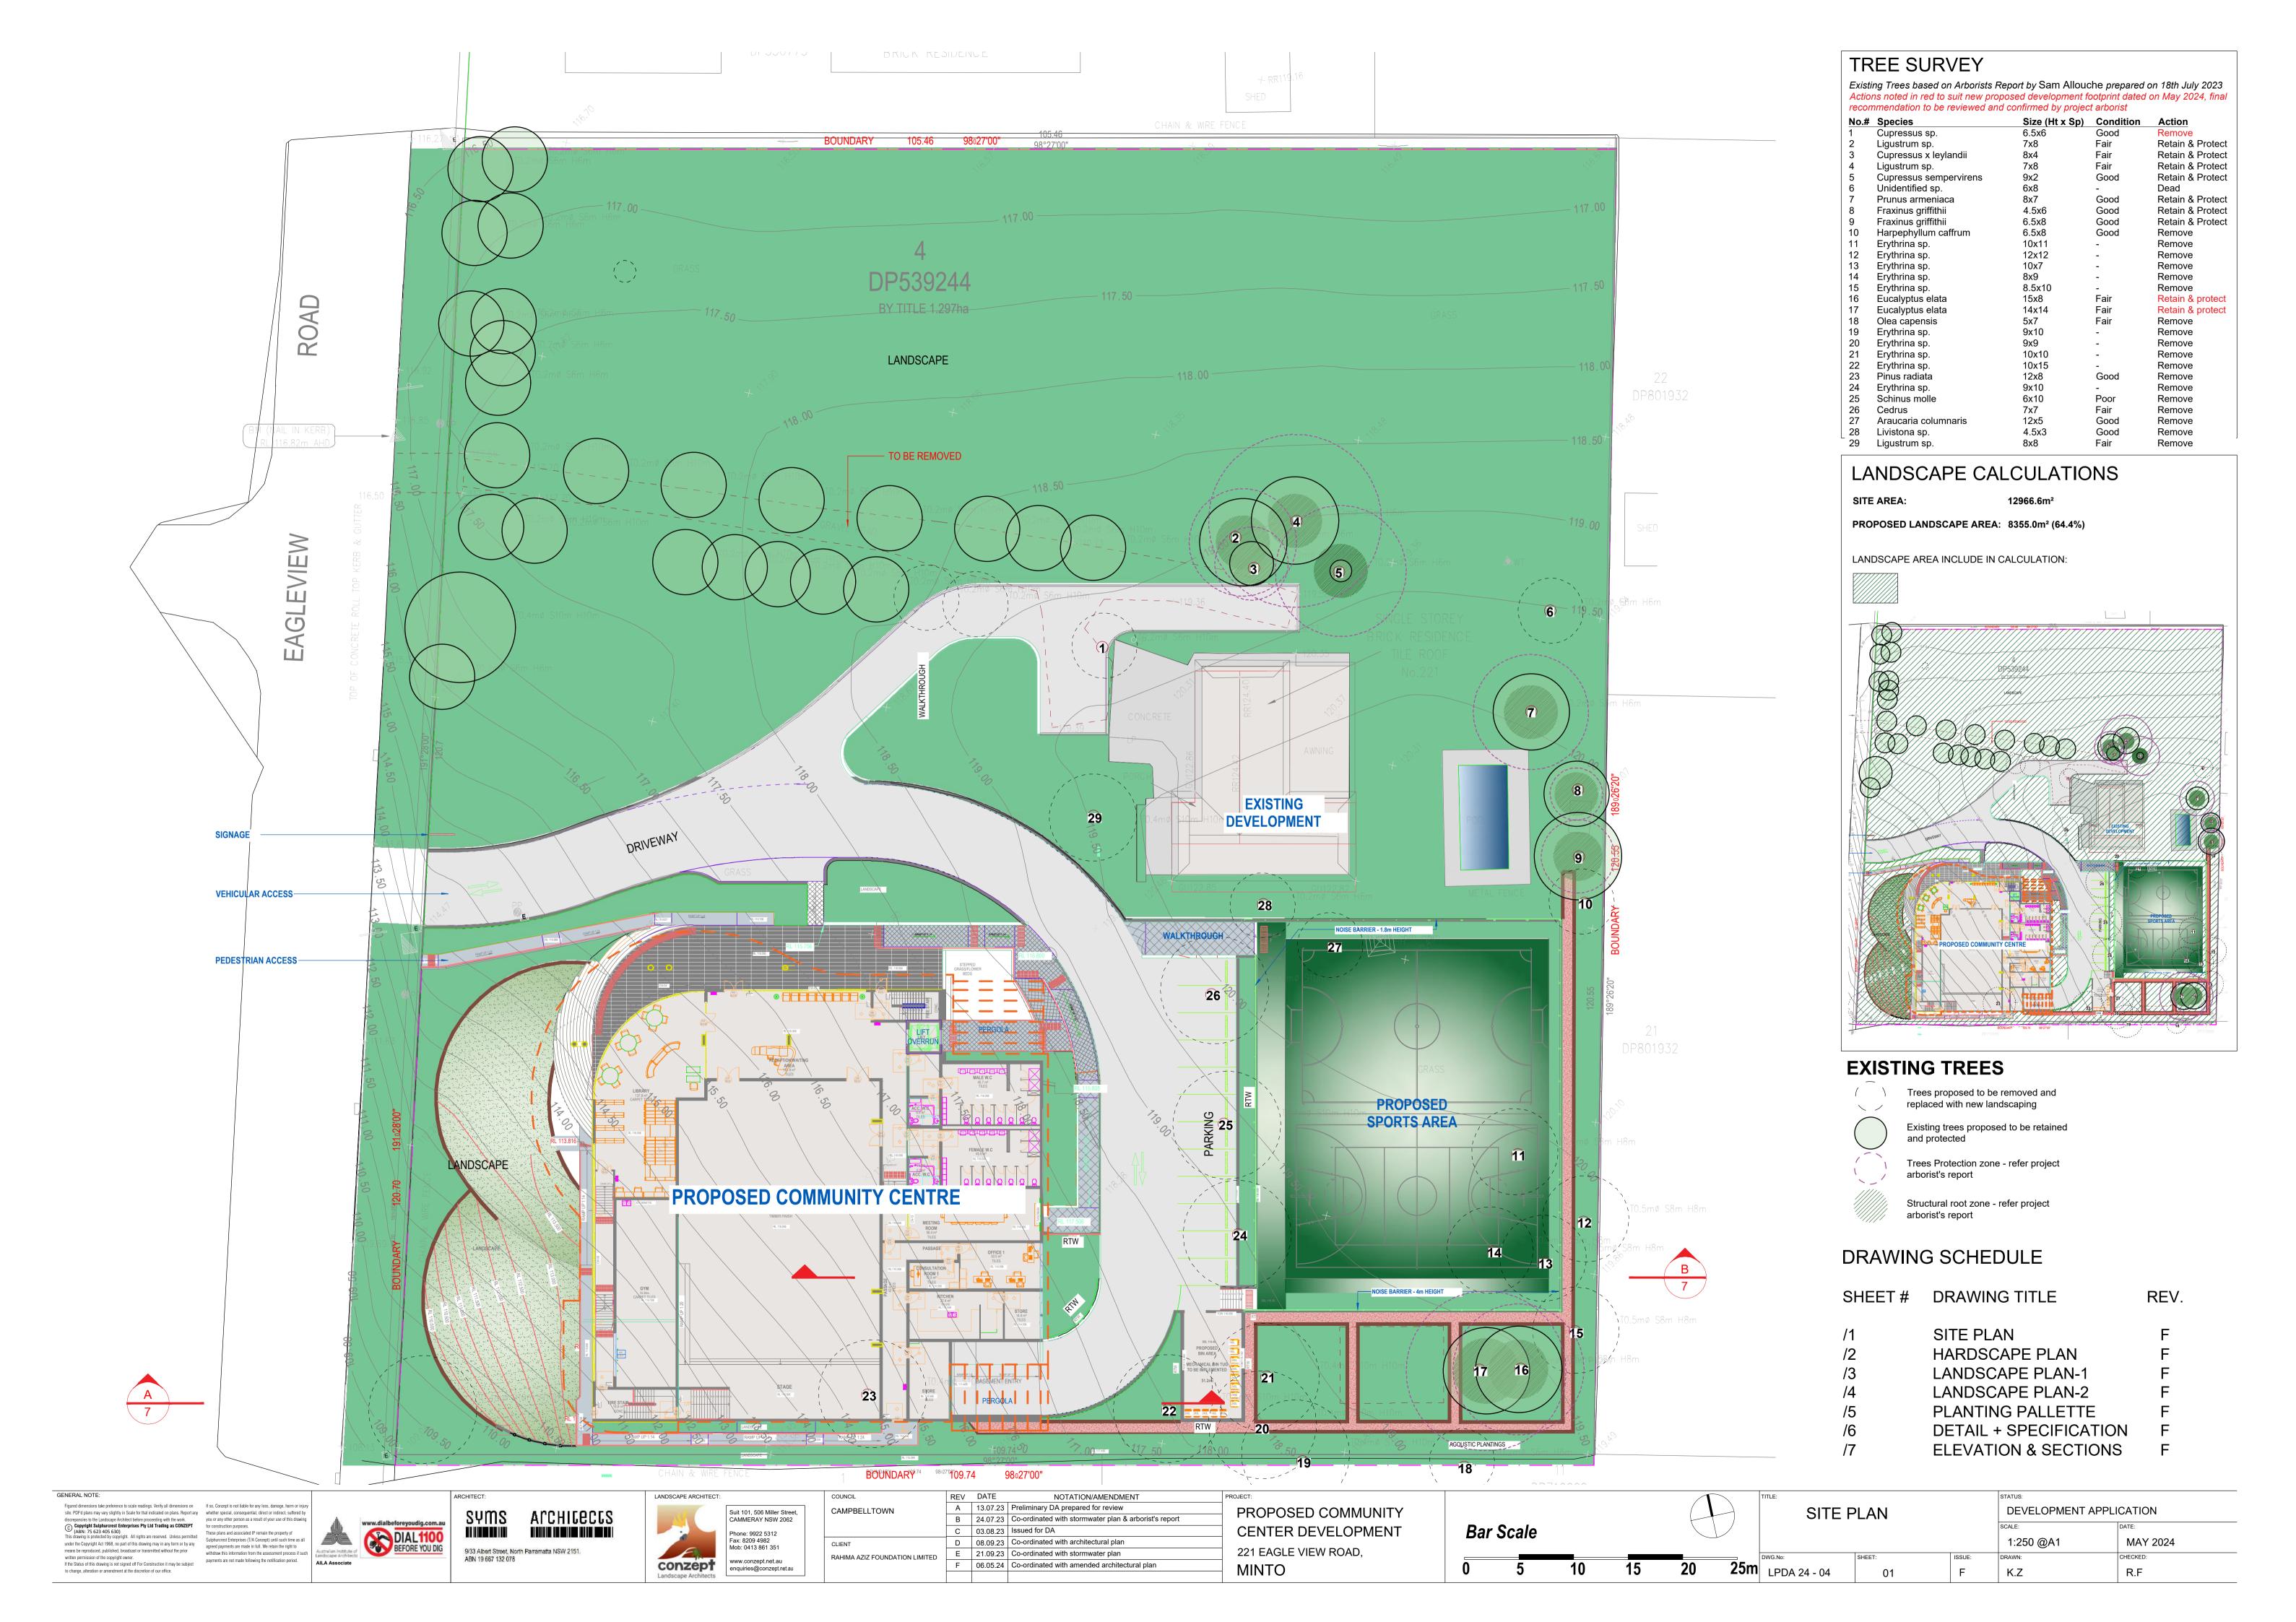
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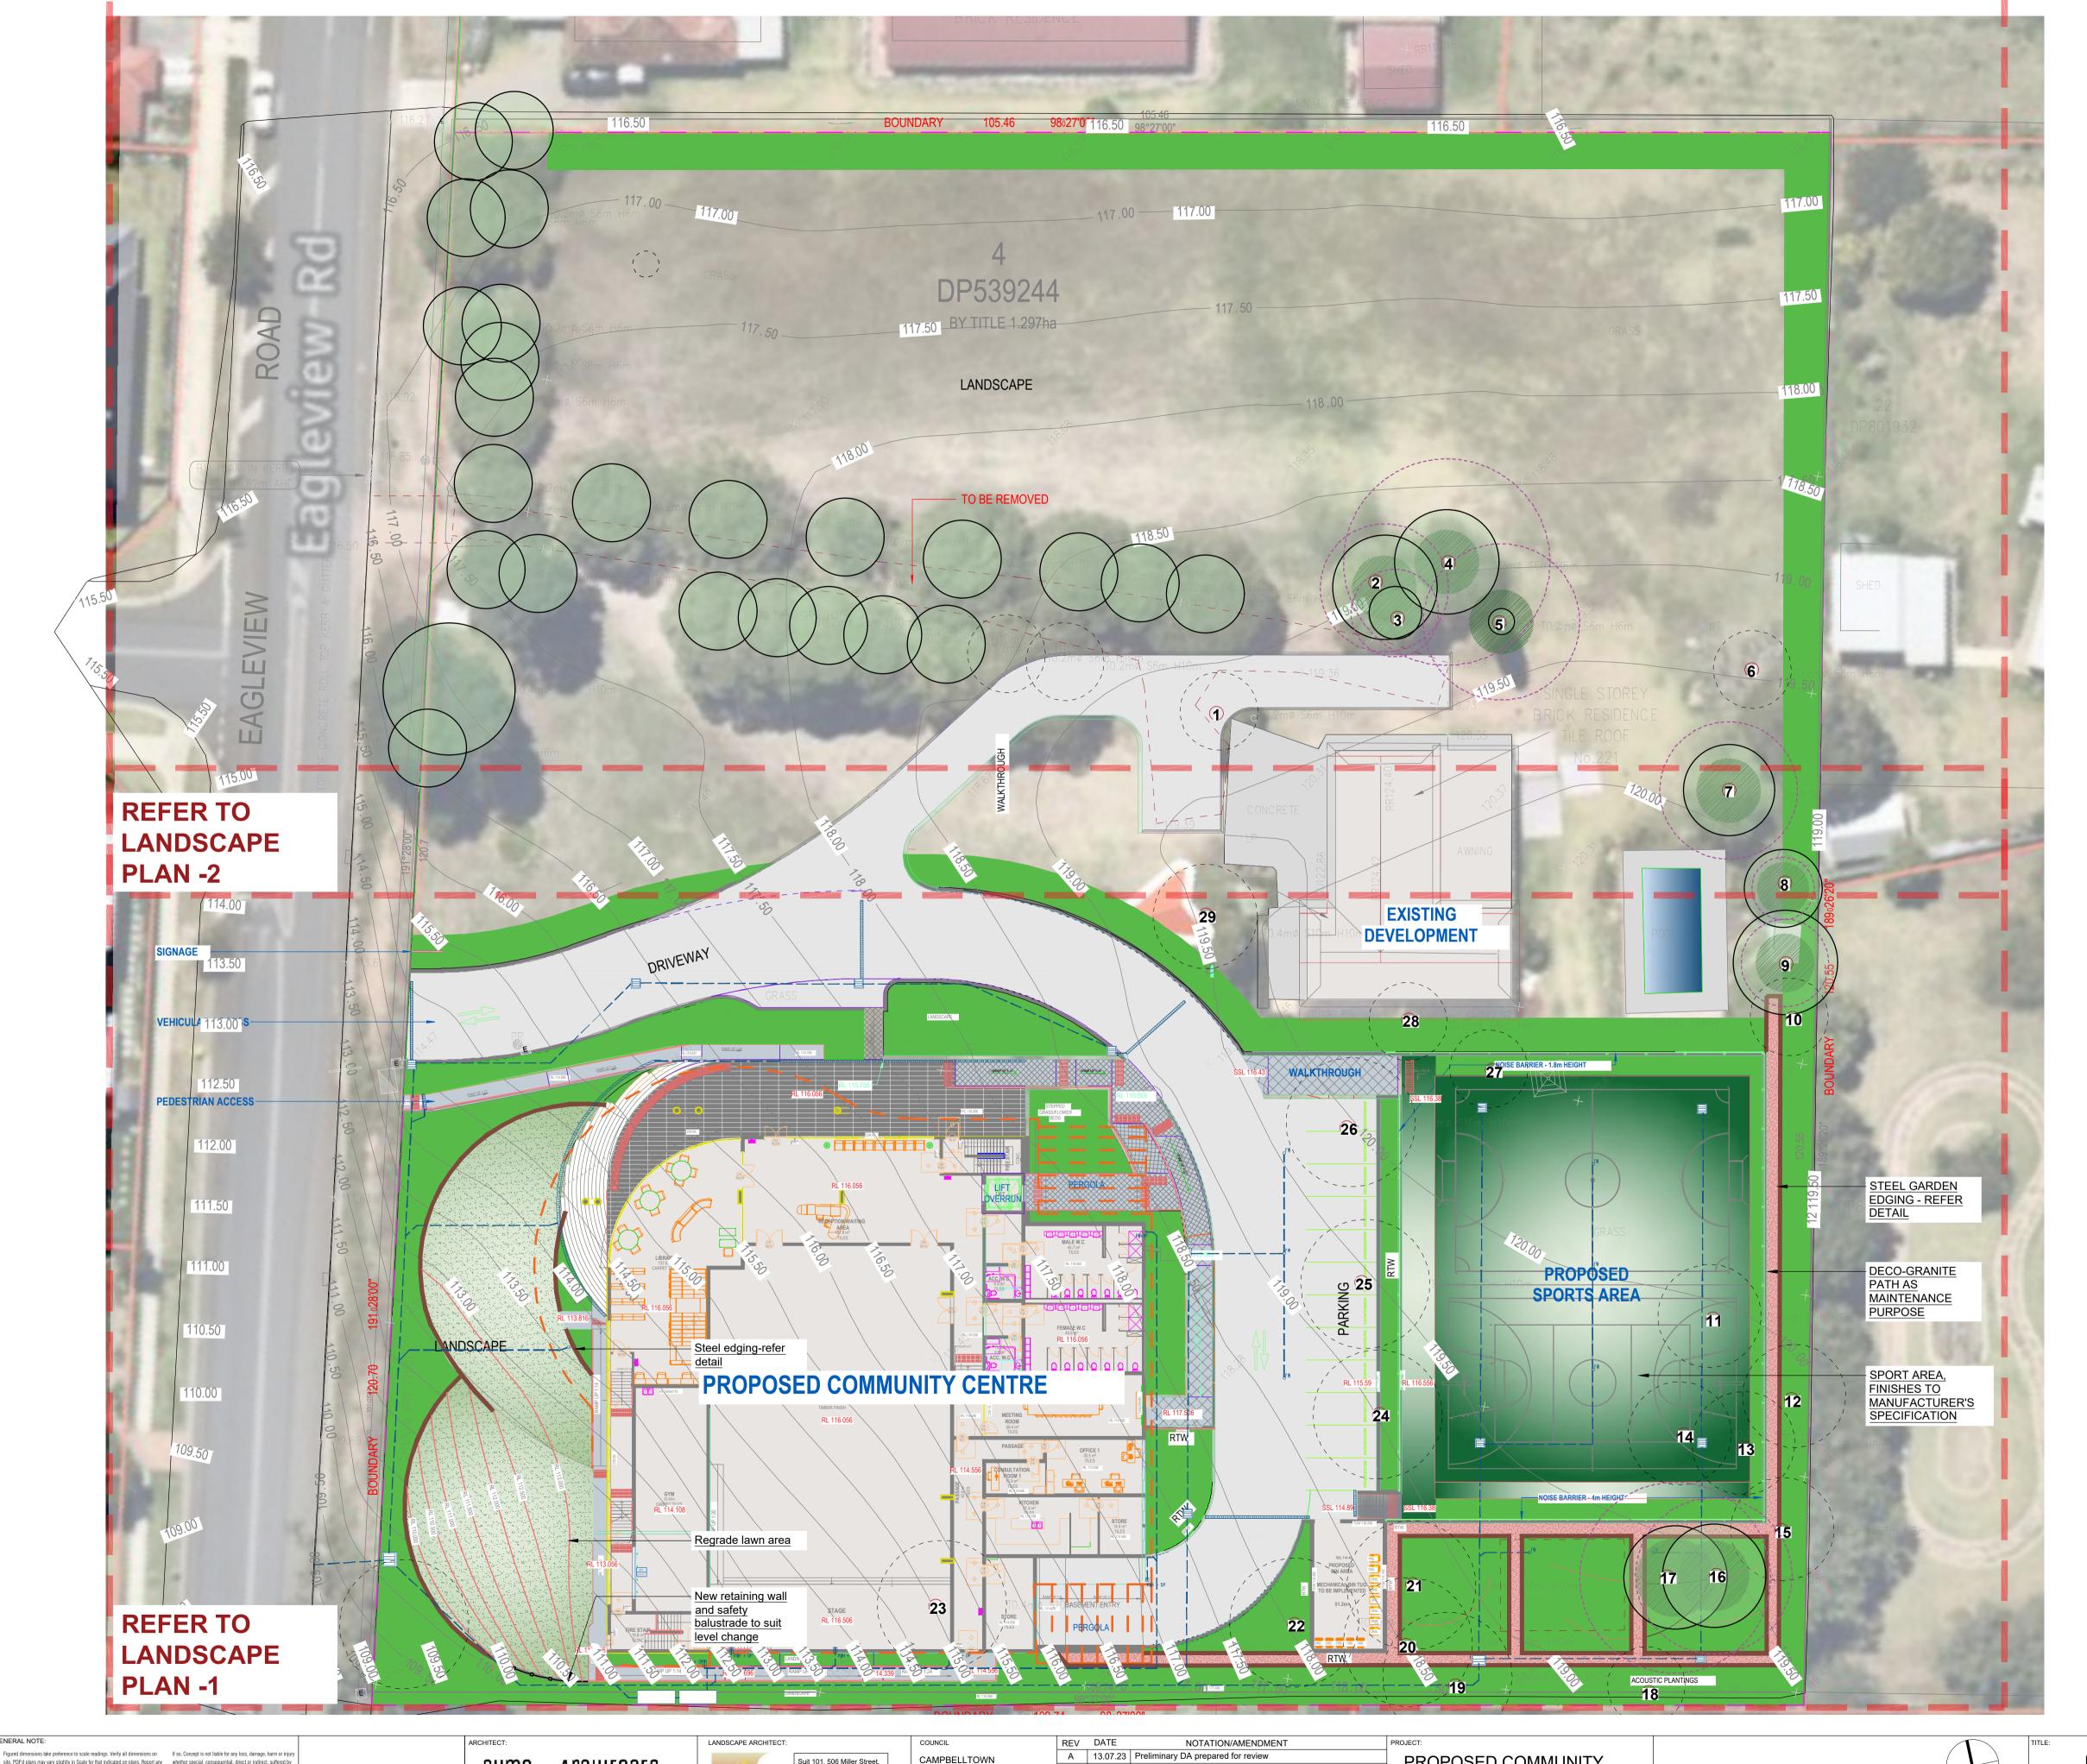
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LOCATION PLAN / Scale: NTS



Street view - 1

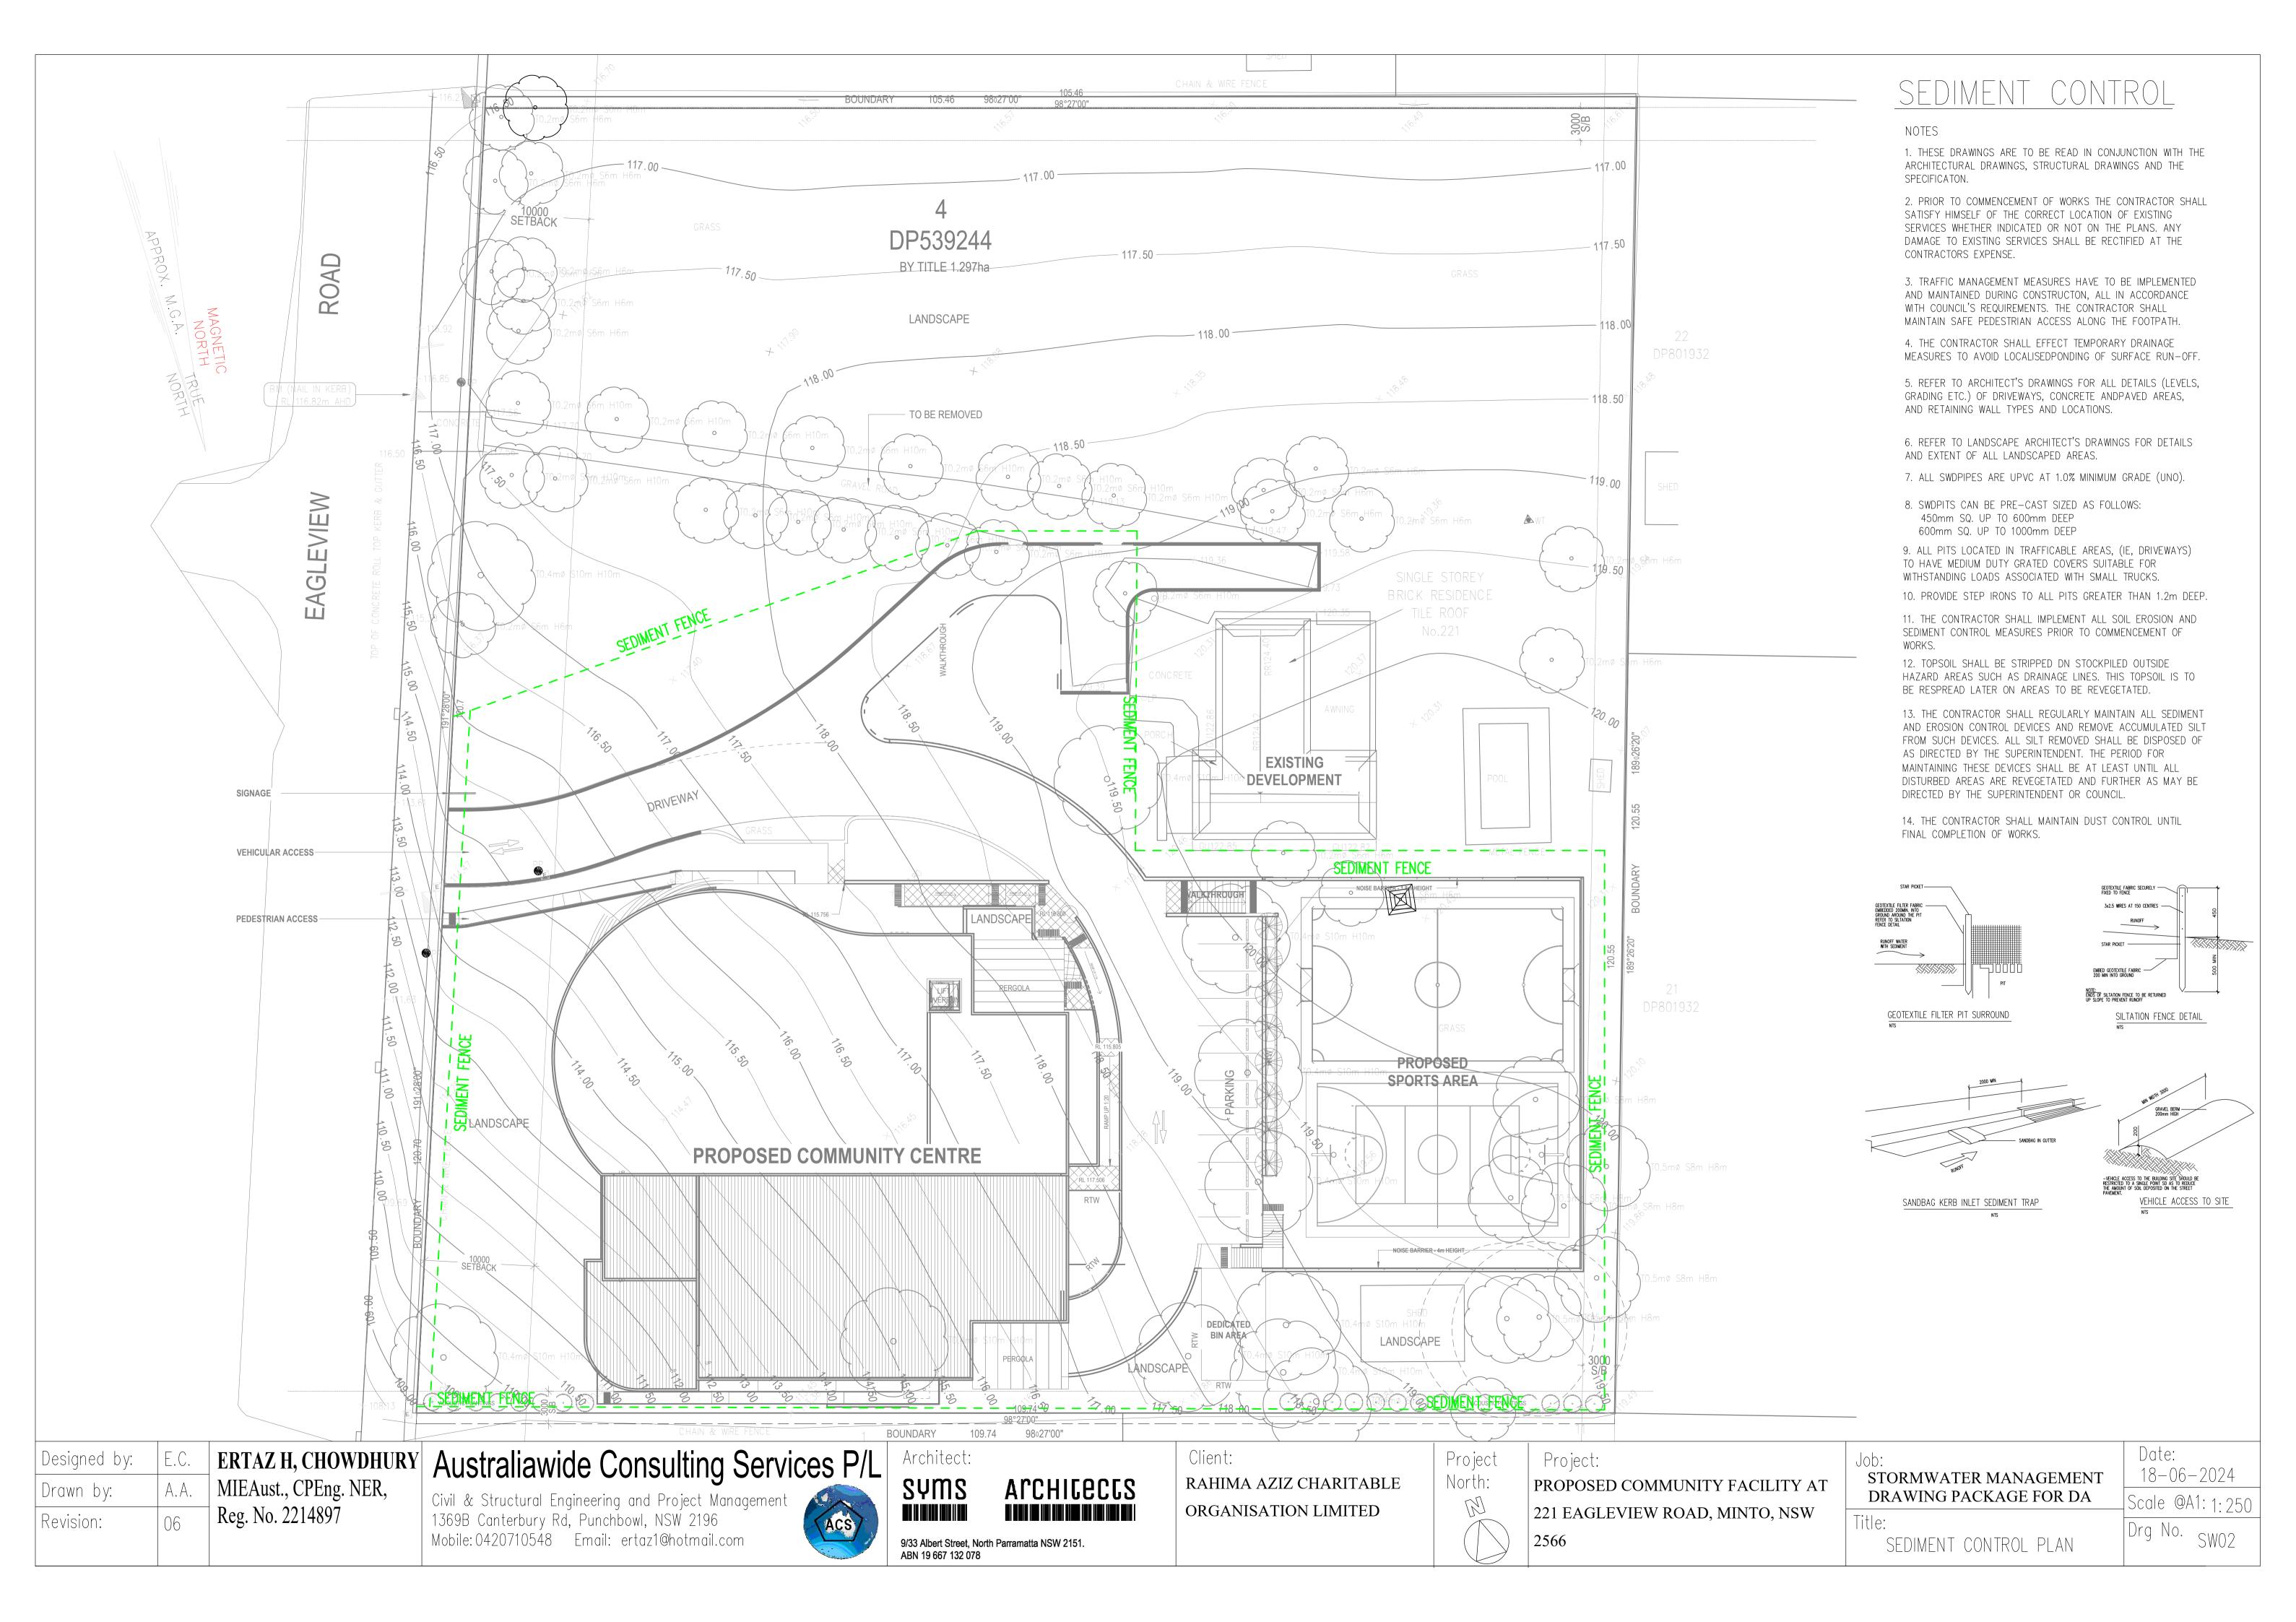

Street view - 2

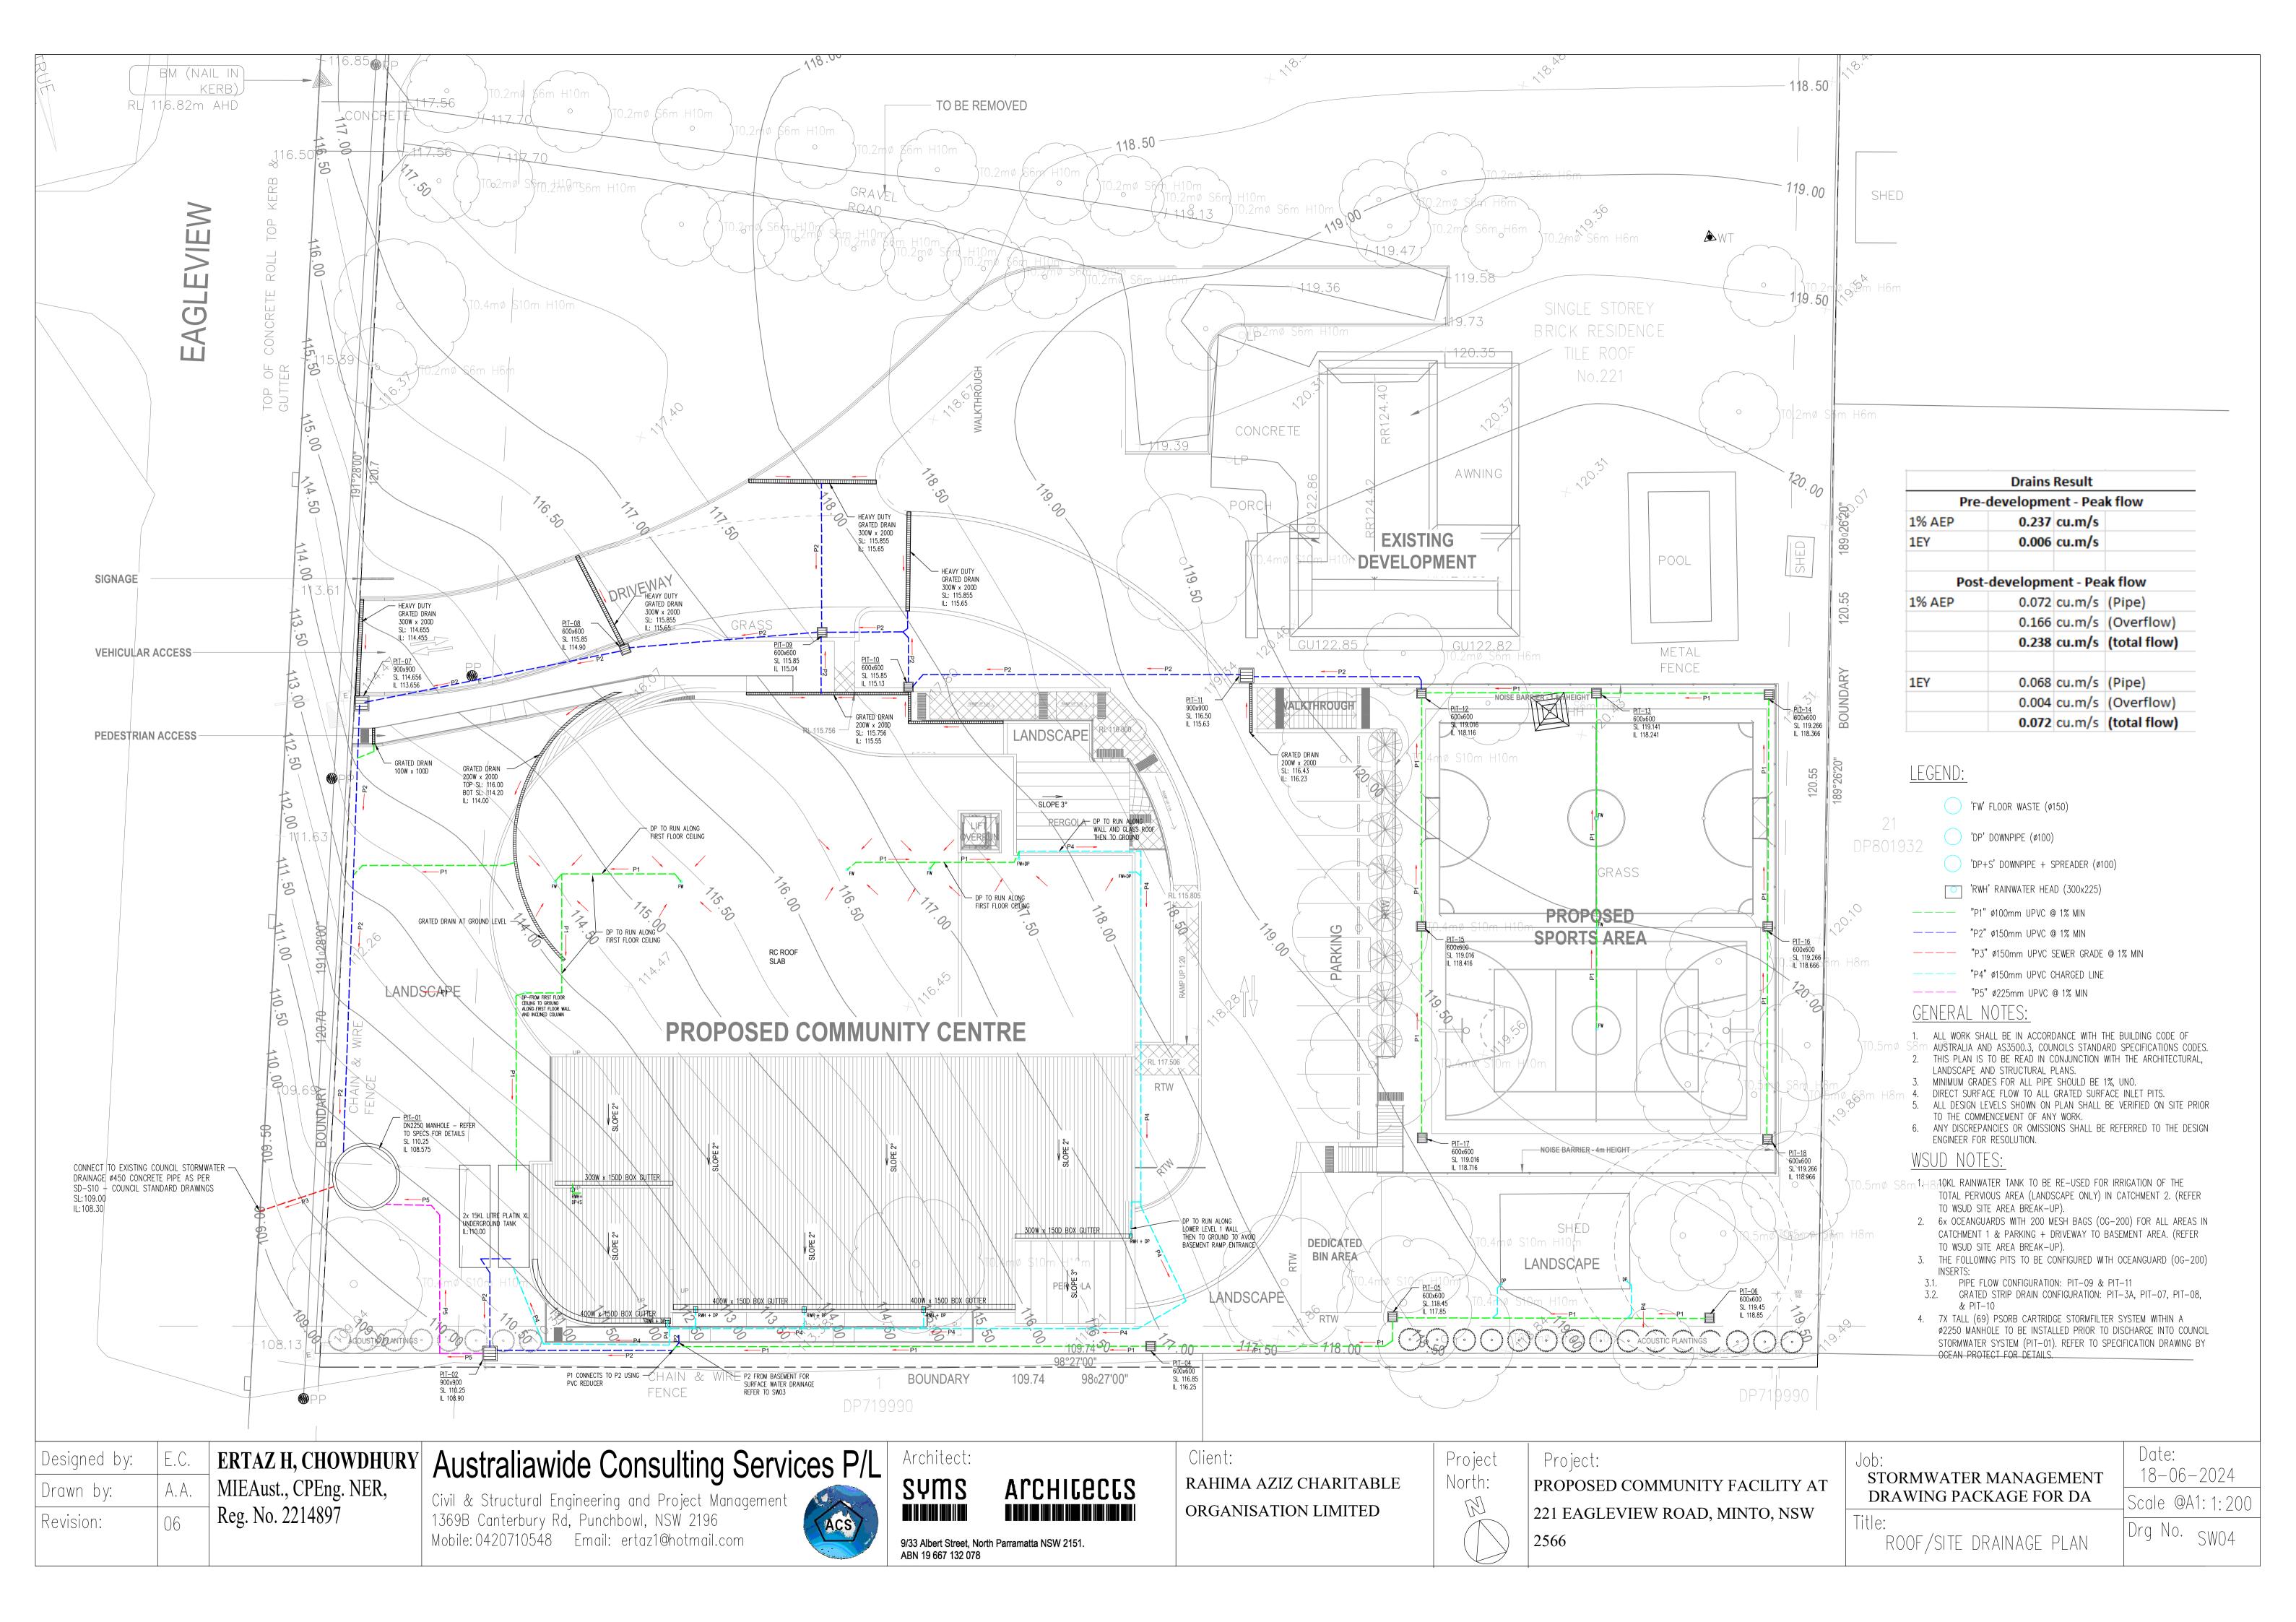

Steel garden edging - refer detail Turf area - refer detail

Garden bed - refer landscape design plan Sport area, finishes to manufacturer's specification

Deco-granite path for maintenance purpose

Retaining / raised planter wall - refer detail

Trees proposed to be removed and replaced with new landscaping

Existing trees proposed to be retained and protected

Trees Protection zone - refer project arborist's report

> Structural root zone - refer project arborist's report



GENERAL NOTE: Figured dimensions take preference to scale readings. Verify all dimensions on site. PDPd plans may vary slightly in Scale for that indicated on plans. Report any discrepancies to the Landscape Architect before proceeding with the work.

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CAMPBELLTOWN RAHIMA AZIZ FOUNDATION LIMITED


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PROPOSED COMMUNITY CENTER DEVELOPMENT 221 EAGLE VIEW ROAD, MINTO

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HARDSCAPE PLAN									
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DEVELOPMENT APPLICATION 1:250 @A1 MAY 2024 CHECKED: R.F K.Z



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NOTATION/AMENDMENT A 13.07.23 Preliminary DA prepared for review B 24.07.23 Co-ordinated with stormwater plan & arborist's report C 03.08.23 Issued for DA 08.09.23 Co-ordinated with architectural plan 21.09.23 Co-ordinated with stormwater plan 06 05 24 Co-ordinated with amended architectural plan

PROPOSED COMMUNITY CENTER DEVELOPMENT 221 EAGLE VIEW ROAD. MINTO

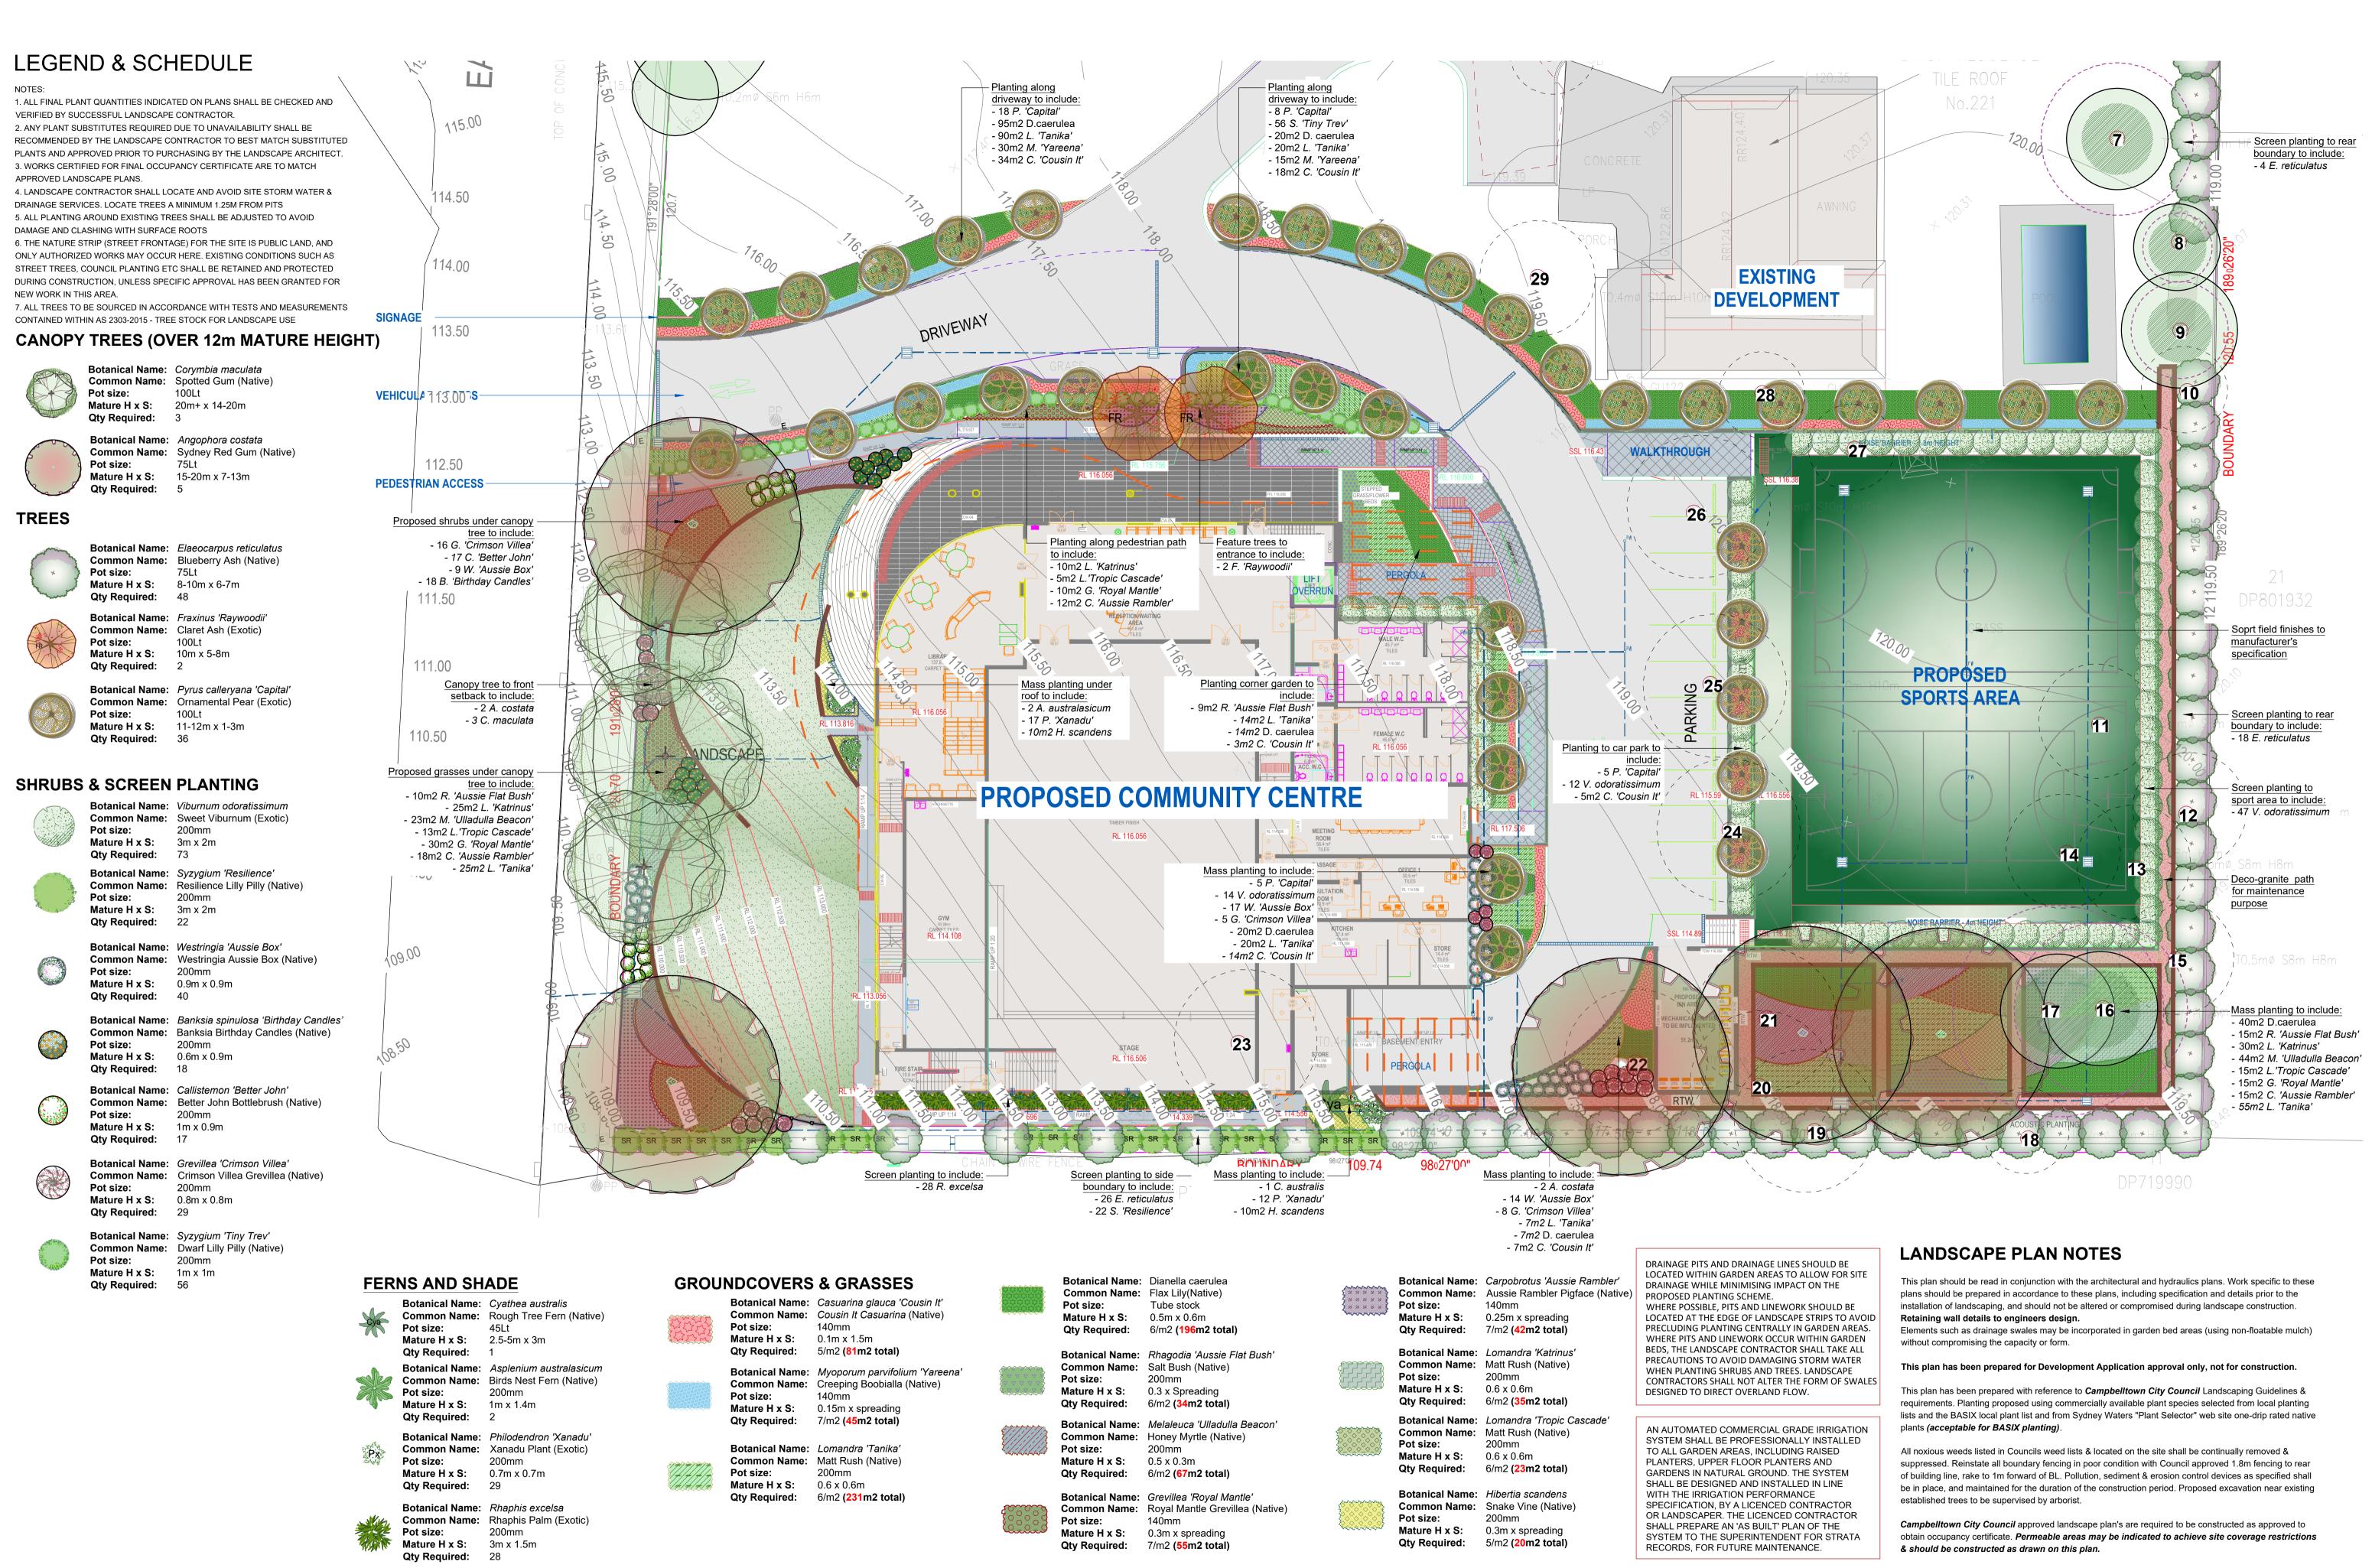LANDSCAPE PLAN DEVELOPMENT APPLICATION Bar Scale 1:200 @A1 MAY 2024 HECKED: R.F

LEGEND & SCHEDULE

1. ALL FINAL PLANT QUANTITIES INDICATED ON PLANS SHALL BE CHECKED AND VERIFIED BY SUCCESSFUL LANDSCAPE CONTRACTOR. 2. ANY PLANT SUBSTITUTES REQUIRED DUE TO UNAVAILABILITY SHALL BE RECOMMENDED BY THE LANDSCAPE CONTRACTOR TO BEST MATCH SUBSTITUTED PLANTS AND APPROVED PRIOR TO PURCHASING BY THE LANDSCAPE ARCHITECT.

3. WORKS CERTIFIED FOR FINAL OCCUPANCY CERTIFICATE ARE TO MATCH APPROVED LANDSCAPE PLANS.

4. LANDSCAPE CONTRACTOR SHALL LOCATE AND AVOID SITE STORM WATER & DRAINAGE SERVICES. LOCATE TREES A MINIMUM 1.25M FROM

5. ALL PLANTING AROUND EXISTING TREES SHALL BE ADJUSTED TO AVOID DAMAGE AND CLASHING WITH SURFACE ROOTS 6. THE NATURE STRIP (STREET FRONTAGE) FOR THE SITE IS PUBLIC LAND, AND ONLY AUTHORIZED WORKS MAY OCCUR HERE. EXISTING CONDITIONS SUCH AS STREET TREES, COUNCIL PLANTING ETC SHALL BE RETAINED AND PROTECTED DURING CONSTRUCTION, UNLESS SPECIFIC APPROVAL HAS BEEN GRANTED FOR NEW WORK IN THIS

7. ALL TREES TO BE SOURCED IN ACCORDANCE WITH TESTS AND MEASUREMENTS CONTAINED WITHIN AS 2303-2015 - TREE STOCK FOR LANDSCAPE USE

Qty Required: 44

TREES



Botanical Name: Elaeocarpus reticulatus Common Name: Blueberry Ash (Native) Pot size: 75Lt **Mature H x S:** 8-10m x 6-7m

DRAINAGE PITS AND DRAINAGE LINES SHOULD BE LOCATED WITHIN IMPACT ON THE PROPOSED PLANTING SCHEME. WHERE POSSIBLE, PITS AND LINEWORK SHOULD BE LOCATED AT THE EDGE OF LANDSCAPE STRIPS TO AVOID PRECLUDING PLANTING CENTRALLY IN GARDEN AREAS. WHERE PITS AND LINEWORK OCCUR WITHIN GARDEN BEDS, THE LANDSCAPE CONTRACTOR SHALL TAKE ALL PRECAUTIONS TO AVOID DAMAGING STORM WATER WHEN PLANTING SHRUBS AND TREES. LANDSCAPE CONTRACTORS SHALL NOT ALTER THE FORM OF SWALES DESIGNED TO DIRECT OVERLAND

AN AUTOMATED COMMERCIAL GRADE IRRIGATION SYSTEM SHALL BE PROFESSIONALLY INSTALLED TO ALL GARDEN AREAS, INCLUDING RAISED PLANTERS, UPPER FLOOR PLANTERS AND GARDENS IN NATURAL GROUND. THE SYSTEM SHALL BE DESIGNED AND INSTALLED IN LINE WITH THE IRRIGATION PERFORMANCE SPECIFICATION, BY A LICENCED CONTRACTOR OR LANDSCAPER. THE LICENCED CONTRACTOR SHALL PREPARE AN 'AS BUILT' PLAN OF THE SYSTEM TO THE SUPERINTENDENT FOR STRATA RECORDS, FOR FUTURE MAINTENANCE.

LANDSCAPE PLAN NOTES

This plan should be read in conjunction with the architectural and hydraulics plans. Work specific to these plans should be prepared in accordance to these plans, including specification and details prior to the installation of landscaping, and should not be altered or compromised during landscape construction. Retaining wall details to engineers design. Elements such as drainage swales may be incorporated in garden bed areas (using non-floatable mulch) without compromising the capacity or

This plan has been prepared for Development Application approval only, not for construction.

This plan has been prepared with reference to *Campbelltown City* Council Landscaping Guidelines & requirements. Planting proposed using commercially available plant species selected from local planting lists and the BASIX local plant list and from Sydney Waters "Plant Selector" web site one-drip rated native plants (acceptable for BASIX planting).

All noxious weeds listed in Councils weed lists & located on the site shall be continually removed & suppressed. Reinstate all boundary fencing in poor condition with Council approved 1.8m fencing to rear of building line, rake to 1m forward of BL. Pollution, sediment & erosion control devices as specified shall be in place, and maintained for the duration of the construction period. Proposed excavation near existing established trees to be supervised by

Campbelltown City Council approved landscape plan's are required to be constructed as approved to obtain occupancy certificate. Permeable areas may be indicated to achieve site coverage restrictions & should be constructed as drawn on this plan.



REFER LANDSCAPE PLAN 1

arborist.

Figured dimensions take preference to scale readings. Verify all dimensions on site. PDP'd plans may vary slightly in Scale for that indicated on plans. Report any whether special, consequential, direct or indirect, suffered by discrepancies to the Landscape Architect before proceeding with the work. you or any other person as a result of your use of this drawing © Copyright Sulphurcrest Enterprises Pty Ltd Trading as CONZEPT (ABN: 75 623 405 630) This drawing is protected by copyright. All rights are reserved. Unless permitted under the Copyright Act 1968, no part of this drawing may in any form or by any means be reproduced, published, broadcast or transmitted without the prior

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			COUNCIL	REV	D
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	REV	DATE	NOTATION/AMENDMENT	PROJE
LTOWN	Α	13.07.23	Preliminary DA prepared for review	
2101111	В	24.07.23	Co-ordinated with stormwater plan & arborist's report	
	С	03.08.23	Issued for DA	
	D	08.09.23	Co-ordinated with architectural plan	
Z FOUNDATION LIMITED	Е	21.09.23	Co-ordinated with stormwater plan	2
TOONDATION LIMITED	F	06.05.24	Co-ordinated with amended architectural plan	
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PROPOSED COMMUNITY **CENTER DEVELOPMENT** 221 EAGLE VIEW ROAD, MINTO

						TITLE: LANDS	SCAPE PLAN		DEVELOPMENT APPLICATION		
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discrepancies to the Landscape Architect before proceeding with the work.

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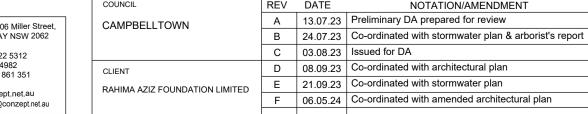








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PROPOSED COMMUNITY CENTER DEVELOPMENT 221 EAGLE VIEW ROAD, MINTO

DEVELOPMENT APPLICATION PLANTING PALLETTE MAY 2024 LPDA 24 - 04 K.Z R.F

PRELIMINARIES 1.01 GENERAL

The following general conditions should be considered prior to the commencement of landscape works:

hydraulic plans, service plans and survey prepared for the proposed development. All services including existing drainage should be accurately located prior to the commencement of landscape installation. Any proposed tree planting which falls close to services will be relocated on site under the

The landscape plans should be read in conjunction with the architectural plans, project arborist's assessment

- instruction of the landscape architect. Installation of conduit for required irrigation, electrical and other services shall be completed prior to the
- commencement of hardscape works and hardstand pours All outdoor lighting specified by architect or client to be installed by qualified electrician
- Anomalies that occur in these plans should be brought to our immediate attention.
- Where an Australian Standard applies for any landscape material testing or installation technique, that

1.02 PROTECTION OF ADJACENT FINISHES

The Contractor shall take all precautions to prevent damage to all or any adjacent finishes by providing adequate protection to these areas / surfaces prior to the commencement of the Works

1.03 PROTECTION OF EXISTING TREES

Existing trees identified to be retained shall be done in accordance with (AS)4970-Protection of trees on development sites as well as in accordance with the tree protection measures prepared by project arborist

Where general works are occurring around such trees, or pruning is required, a qualified Arborist shall be engaged to oversee such works and manage tree health

Existing trees designated on the drawing for retention shall be protected at all times during the construction period. Any soil within the drip-line of existing trees shall be excavated and removed by hand only. No stockpiling shall occur within the root zone of existing trees to be retained.

Any roots larger in diameter than 50mm shall only be severed under instruction by a qualified arborist. Roots smaller than 50mm diameter shall be cut cleanly with a saw.

Temporary fencing shall be installed around the base of all trees to be retained prior to the commencement of landscape works. Where possible this fencing will be located around the drip line of these trees, or a minimum of 3m from the trunk. The fencing shall be maintained for the full construction period.

1.04 EROSION & POLLUTION CONTROL

The Contractor shall take all proper precautions to prevent the erosion of soil from the subject site. The contractor shall install erosion & sediment control barriers and as required by council, and maintain these barriers throughout the construction period. Note that the sediment control measures adopted should reflect the soil type and erosion characteristics of the site.

Erosion & pollution control measures shall incorporate the following:

- Construction of a sediment trap at the vehicle access point to the subject site. - Sediment fencing using a geotextile filter fabric in the location indicated on the erosion control plan or as instructed on

site by the landscape architect - Earth banks to prevent scour of stockpiles - Sandbag kerb sediment traps

- Straw bale & geotextile sediment filter. - Exposed banks shall be pegged with an approved Jute matting in preparation for mass planting

Refer to "Sitewise Reference Kit" as prepared by DLWC & WSROC (1997) for construction techniques

2.01 MATERIALS

Specified Soil Conditioner (Generally to improve site soil)

The specified soil conditioner for site top-soil improvement shall be an organic mix, equal to "Botany Humus", as supplied by ANL. Note that for sites where soil testing indicates toxins or extremes in pH, or soils that are extremely poor, allow to excavate and supply 300mm of imported soil mix.

New gardens & proposed Planting

New garden and planting areas shall consist of a 50/50 mix of clean site soil (refer d) below) and imported "Organic Garden Mix" as supplied by ANL or approved equal. All mixes are to comply with AS 4419 Soils for landscaping & garden use, & AS 4454 Composts, Soil conditioners & mulches.

The specified soil mix for all turf areas shall be a min 75mm layer of imported soil mix consisting of 80% washed river sand (reasonably coarse), and 20% composted organic matter equivalent to mushroom compost or soil conditioner, or other approved lawn top dress.

Site topsoil is to be clean and free of unwanted matter such as gravel, clay lumps, grass, weeds, tree roots, sticks, rubbish and plastics, and any deleterious materials and materials toxic to plants. The topsoil must have a pH of between 5.5 and 7. Use 100% imported soil mix when site when site topsoil runs out.

2.02 INSTALLATION (TO GARDEN OUTSIDE OF TREE PROTECTION ZONES OF TREES RECOMMENDED TO BY

Note: No level changes (Cut or Fill), soil ripping within the Tree Protection Zones of trees to be retained

All testing is to be conducted in accordance with AS 1289 Methods for testing soils for engineering purposes. Site soil shall be given a pH test prior to modifying to ensure conditions are appropriate for planting as stated above. Tests shall be taken in several areas where planting is proposed, and the pH shall be adjusted accordingly with sulphur or lime to

Note that a soil test conducted by the "Sydney Soil Lab" or approved equal shall be prepared for all commercial, industrial and multi-unit residential sites. The successful landscape contractor shall implement the recommendations of

b) Set Out of Individual Trees & Mass Planting Areas

All individual tree planting positions and areas designated for mass planting shall be set out with stakes or another form

of marking, ready for inspection and approval. Locate all services.

c) Establishing Subgrade Levels outside of tree protection zones of trees to be retained Subgrade levels are defined as the finished base levels prior to the placement of the specified material (i.e. soil

conditioner). The following subgrade levels shall apply: Mass Planting Beds - 300mm below existing levels with specified imported soil mix

Turf areas - 100mm below finished surface level. Note that all subgrades shall consist of a relatively free draining natural material, consisting of site topsoil placed previously by the Civil Contractor. No builders waste material shall be acceptable.

d) Subgrade Cultivation

Cultivate all subgrades to a minimum depth of 100mm in all planting beds and all turf areas, ensuring a thorough breakup of the subgrade into a reasonably coarse tilth. Grade subgrades to provide falls to surface and subsurface drains, prior to

e) Drainage Works

Install surface and subsurface drainage where required and as detailed on the drawing. Drain subsurface drains to

f) Placement and Preparation of Specified Soil Conditioner & Mixes.

outlets provided, with a minimum fall of 1:100 to outlets and / or service pits.

Trees in turf & beds - Holes shall be twice as wide as root ball and minimum 100mm deeper - backfill hole with 50/50 mix of clean site soil and imported "Organic Garden Mix" as supplied by ANL or approved equal.

Mass Planting Beds - Install specified soil conditioner to a compacted depth of 100mm Place the specified soil conditioner to the required compacted depth and use a rotary hoe to thoroughly mix the conditioner into the top 300mm of garden bed soil. Ensure thorough mixing and the preparation of a reasonably fine tilth

and good growing medium in preparation for planting. Turf Areas - Install specified soil mix to a minimum compacted depth of 75mm. Place the specified soil mix to the required compacted depth and grade to required finished soil levels, in preparation for

planting and turfing. PLANTING

3.01 MATERIALS

a) Quality and Size of Plant Material

Below - Ground Assessment:

All trees supplied above a 25L container size must be grown and planted in accordance with AS 2303:2018 'TREE STOCK FOR LANDSCAPE USE' Certification that trees have been grown to AS 2303:2018 is to be provided upon request of Council's Tree Management Officer.

Above - Ground Assessment:

The following plant quality assessment criteria should be followed Plant true to type, Good vigour and health, free from pest & disease, free from injury, self-supporting, good stem taper, has been pruned correctly, is apically dominant, has even crown symmetry, free from included bark & stem junctions, even trunk position in pot, good stem structure

Good root division & direction, rootball occupancy, rootball depth, height of crown, non-suckering For further explanation

and description of these assessment criteria, refer to Ross Clark's book All Plant material shall be to the type and size specified. No substitutions of plant material shall be permitted without

written prior approval by the Landscape Architect. No plant shall be accepted which does not conform to the standards listed above.

b) Stakes and Ties Provide min. 3 No. Stakes and ties to all plants identified as trees in the plant schedule. Stakes shall be sound, unpainted,

per council specification where is available. Ties shall be 50mm wide hessian webbing material

straight hardwood, free of knots and pointed at one end. They shall be 1800mm x 50mm x 50mm Hardwood timber, or as

AILA Associate

Fertilisers shall be approved slow release fertilisers suitable for the proposed planting types. Note that for native plants, specifically Proteaceae family plants including Grevillea species, low phosphorus fertilizers shall be used.

d) Mulch Mulch for general planter bed shall be an approved equal to "EUCY" as supplied by ANL. Mulch shall be completely free from any soil, weeds, rubbish or other debris. Mulch for bio-retention/rain garden area where is required shall be non-floatable materials that could include crushed rock, gravel, coarse river sand, scoria or river pebbles. 4-7mm

Turf for project site shall be soft leaf Buffalo or Zoysia macrantha 'Nana' or equivalent unless stated otherwise), free from any weeds and other grasses, and be in a healthy growing condition. Re-turfing to nature strip where is required

3.02 INSTALLATION

shall use species that match existing on street.

a) Setting Out

All planting set out shall be in strict accordance with the drawings, or as directed. Note that proposed tree planting located near services should be adjusted at this stage. Notify Landscape Architect for inspection for approval prior to

screenings or similar.

All plant material shall be planted as soon after delivery as possible. Planting holes for trees shall be excavated as detailed and specified. Plant containers shall be removed and discarded, and the outer roots gently teased from the soil mass. Immediately set plant in hole and backfill with specified soil mix, incorporating the approved quantity of fertiliser for each plant type. Ensure that plants are set plumb vertically and root balls set to the consolidated finished grades detailed on the drawings. Compact the backfilled soil and saturate by hand watering to expel any remaining air pockets

Staking and tying shall be in strict accordance with the drawings and shall occur immediately following plant placement and soil backfilling. All plants identified as "Trees" on the planting schedule shall be staked with a min. 3 stakes.

Mulch for general planter bed shall be an approved equal to "EUCY" as supplied by ANL. Mulch shall be completely free from any soil, weeds, rubbish or other debris. Mulch for bio-retention/rain garden area where is required shall be non-floatable materials that could include crushed rock, gravel, scoria or river pebbles. 4-7mm screenings or similar.

Moisten soil prior to the turf being laid. Turf shall be neatly butt jointed and true to grade to finish flush with adjacent surfaces. Incorporate a lawn fertilizer and thoroughly water in. Keep turf moist until roots have taken and sods/rolls cannot be lifted. Keep all traffic off turf until this has occurred. Allow for top dressing of all turf areas. All turf shall be rolled immediately following installation

f) Steel garden edging Where is required, the Contractor shall install Brick garden edging as detailed on the drawings, to all mass planting beds adjoining turf or gravel mulched areas, and where required. The resultant edge shall be true to line and flush with adjacent surfaces. However, no edging shall be used within the Structural Root Zone (SRZ) of trees to be retained.

All walls which form part of drainage works must be built as detailed by the hydraulic engineer. All walls exceeding 800mm shall be of not timber construction materials, construction details to be provided by a qualified engineer. Install wall to suit site levels and to manufacture's specification.

HARDSCAPE WORKS 4.01 GENERAL

The Contractor shall undertake the installation of all hardscape works as detailed on the drawing, or where not detailed

by manufacturers specification. Paving - refer to typical details provided, and applicable Australian Standards, Permeable paving may be used as a suitable means of satisfying Council permeable surface requirements, while providing a useable, hardwearing, practical surface. In most instances, the client shall nominate the appropriate paving material to

Australian Standards shall be adhered to in relation to all concrete, masonry & metal work. Some details are typical and may vary on site. All hardscape works shall be setout as per the drawings, and inspected and approved by the Landscape Architect prior to installation. All workmanship shall be of the highest standard. Any queries or problems that arise from hardscape variations should be bought to the attention of the Landscape Architect Your attention is directed to any obligations or responsibilities under the Dividing Fences Act, 1991 in respect of adjoining property owner/s which may arise from this application. Any enquiries in this regard may be made to the Crown Lands

Division on (02) 8836 5332. **IRRIGATION WORKS**

5.01 GENERAL (PERFORMANCE SPECIFICATION)

New irrigation systems to planting areas shall be a Commercial Grade Irrigation System conforming to all relevant Australian standards, including AS 3500 & the Electrical Safety Act 2002, Workplace Health & Safety Act 2011, & the latest Sydney Water Code

An automated drip-irrigation system is to be installed to all gardens, planters and lawn areas in accordance with the

This system shall be designed and installed by a qualified and licensed irrigation specialist, to industry standards and to maximise the efficient usage of water.

- The Landscape Contractor nominated Licensed Irrigation Specialist shall provide irrigation drawings for approval upon

- The irrigation system shall be installed prior to all planting works. It shall incorporate a commercially available irrigatior system, with sub-surface dripper lines to irrigate all gardens, planters and lawn areas. - It shall incorporate a suitable back flow prevention device for the scale of works, an in-line filter, check valves, and

- suitable high and low density poly hose fittings and PVC piping to achieve flow rates suitable for specified planting - The irrigation application rate shall not exceed the infiltration rate of the soil or creates run-off. - The landscape contractor shall check the existing pressure available from the ring mains and size irrigation piping to suit. Supply shall be from local hose cock where available.
- All piping and fittings shall be buried 50mm below the finished soil levels in garden and lawn areas, and secured in position at 500mm centres with galv wire pins. - Size of pipes shall be selected to ensure the working pressure at the end of the line does not decrease by more than

Services Co-ordination

- Co-ordination required by Landscape Contractor or Project Manager to provide required conduit, pipe work and penetration through slabs and planter walls for water and power provisions.

- The Landscape Contractor shall be engaged with the Irrigation Specialist to co-ordinate with the Project Manager to identify the preferred service and conduit locations. - Project Manager and Landscape Contractor to establish area suitable for irrigation control system with required area. power provision and water supply.

Testing & Defects:

Upon completion of installation, the system shall be tested, including:

- Main Line Pressure Test: The main line is pressurised to test for leaks. All valves are shut and the pressure is taken over a determined length of time. - Dripper Pressure Test: Measurement at flushing valves are taken and the pressure gauged to make sure it conforms to

the manufacturer recommendations. The inlet pressure is then tested under the same conditions to check it does not exceed 300Kpa. - All components are to be satisfactorily functional and operational prior to approval. Should any defect develop, or the capacity or efficiency of the system decline during the agreed maintenance system, then these faults shall be immediately rectified.

- A full 12 month warranty shall be included to cover labour and all parts.

Further Documentation:

- On request, a detailed irrigation performance specification report can be issued.

CONSOLIDATION AND MAINTENANCE

The consolidation and maintenance period shall be either 6 months beginning from the approved completion of the specified construction work (Practical Completion) as agreed to in the landscape contractors contractual obligations.

or as specified by Council in the Determination. A qualified landscape maintenance contractor shall undertake the required landscape maintenance works. Consolidation and maintenance shall mean the care and maintenance of Contracted works by accepted landscaping or horticultural practices, ensuring that all plants are in optimum growing conditions and appearance at all times, as well as rectifying

any defects that become apparent in the contracted works.

- This shall include, but not be limited to, the following items where and as required:
- Watering all planting and lawn areas / irrigation maintenance. • Clearing litter and other debris from landscaped areas. • Removing weeds, pruning and general plant maintenance.
- Replacement of damaged, stolen or unhealthy plants. Make good areas of soil subsidence or erosion.
- Topping up of mulched areas Spray / treatment for Insect and disease control

ARCHITECT

ABN 19 667 132 078

9/33 Albert Street, North Parramatta NSW 2151.

 Fertilizing with approved fertilizers at correct rates. • Mowing lawns & trimming edges each 14 days in summer or 18 days in winter


superintendent or landscape architect, the responsibility will be signed over to the client.

Archiceccs

- Adjusting ties to Stakes • Maintenance of all paving, retaining and hardscape elements.
- On the completion of the maintenance period, the landscape works shall be inspected and at the satisfaction of the

LANDSCAPE ARCHITECT Suit 101, 506 Miller Street Phone: 9922 5312

Fax: 8209 4982 Mob: 0413 861 351 conzept enquiries@conzept.net.au

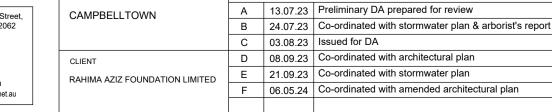

SCALE: 1:10

METAL GARDEN EDGE DETAIL

NOTATION/AMENDMENT

PLANT STOCK SHALL BE

SOURCED FROM GROWERS

CONFORMING TO AS 2303:2018

'TREE STOCK FOR LANDSCAPE

USE' THOROUGHLY WATER IN

ALL NEWLY PLANTED STOCK

-QUALITY OF PLANT TO BE APPROVED BY PROJECT

MANAGER OR LANDSCAPE

PROVIDE 3 HARDWOOD STAKES

TREES. USE 50mm HESSIAN TIES

TO SECURE LOWER TRUNK TO

1.8m X 50mm X 50mm FOR ALL

ARCHITECT

STAKES

75mm 'EUCY' MULCH OR

ARCHITECT

ROOT BARRIER WHERE TREES ARE

(ONLY APPLICABLE FOR PLANTING AREA OUTSIDE TREE

RIPPING/CULTIVATING OF THE SOIL WITHIN THE TPZ OF

ARE TO OCCUR TO EXISTING LEVELS, INCLUDING

PROTECTION ZONE OF TREES TO BE RETAINED. NO CHANGES

TREE PLANTING DETAIL

TREES TO BE RETAINED ON SITE)

PLANTING IN CLOSE PROXIMITY TO HARD

EQUAL

PROVIDE SLIGHT

DEPRESSION TO ALLOW

BACKFILL HOLE WITH

TOP-SOIL BLEND OR

IMPORTED SOIL MIX

APPROVED BY LANDSCAPE

-CULTIVATE/ RIP SUBGRADE

CLEAN. TESTED SITE

FOR EFFECTIVE WATERING


IMMEDIATELY AFTER PLANTING.

75mm DEPTH "EUCY" MULCH OR **EQUIVALENT** SOIL MIX: SPECIFIED 50% OF STOCKPILED SITE TOPSOIL **PLANTING &** FREE FROM ALL BUILDER'S RUBBISH POT SIZE AND DELETERIOUS MATERIALS. TOPSOIL TO BE AMELIORATED, MIXED WITH MINIMUM 50% IMPORTED GARDEN MIX OR SOIL CONDITIONER/ 300mm DERTH SOIL MIX BLEND COMPOSTED ORGANIC MATTER - SEE USE 100% IMPORTED SOIL MIX WHEN SUBSOIL CULTIVATED TO 100mm SITE TOPSOIL RUNS OUT. TYPICAL GARDEN PREPARATION DETAIL

TYPICAL SETBACK FROM

LAWN/GARDEN EDGE

(ONLY APPLICABLE FOR PLANTING AREA OUTSIDE TREE PROTECTION ZONE OF TREES TO BE RETAINED. NO CHANGES ARE TO OCCUR TO EXISTING LEVELS, INCLUDING RIPPING/CULTIVATING OF THE SOIL WITHIN THE TPZ OF TREES TO BE RETAINED ON SITE)

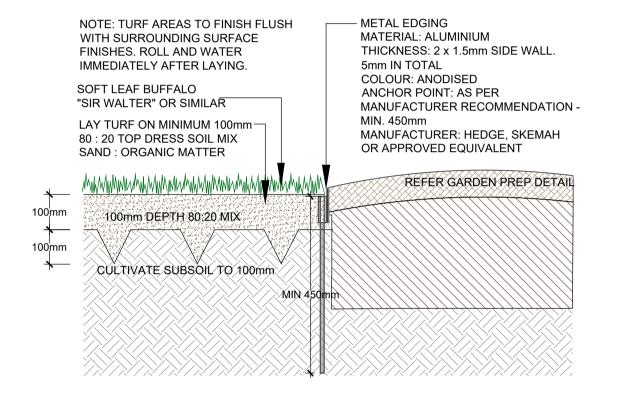

TURF WITH METAL GARDEN EDGE DETAIL

STAINLESS STEEL EDGING PINNED INTO SUBGRADE - FINISH FLUSH WITH SURROUNDING SURFACES SPECIFIED PLAN AT JUNCTIONS FIX 150 100mm DEPTH OF DECOMPOSED. SURFACE LENGTH PLATE ACROSS SCALE: 1:10 GRANITE COMPACTED TO 75mm FINISH JOIN, FIX WITH BOLTS WITH 20% CEMENT ADDED TO MIX TO PROVIDE STABILITY. -100 X 5 MM PLATE - 75 LENGTH PIPE WELDED TO PLATE GEOFABRIC LAYER - 450 LENGTH R10 BAR DRIVEN INTO GROUND **SECTION SECTION** DETAIL SCALE: 1:10

DECO-GRANITE SIDE PATH WITH STEEL **GARDEN EDGING**

SCALE 1:5


PROPOSED COMMUNITY CENTER DEVELOPMENT 221 EAGLE VIEW ROAD, MINTO

SCHEDULE MASS PLANTING SETOUT

-STAGGERED PLANTING TO

PLANTS AS PER

SPECIFIED DENSITIES AS SHOWN

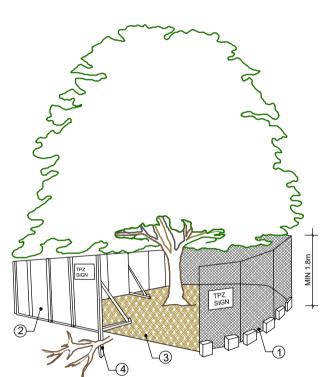

1. CHAIN WIRE MESH PANELS WITH SHADE CLOTH (IF REQUIRED) ATTACHED, HELD IN PLACE WITH CONCRETE FEET

2. ALTERNATIVE PLYWOOD OR WOODEN PALING FENCE PANELS. THE FENCING MATERIAL ALSO PREVENTS BUILDING MATERIALS OR SOIL ENTERING THE TPZ

3. MULCH INSTALLATION ACROSS

SURFACE OF TPZ (AT THE DISCRETION OF THE PROJECT ARBORIST). NO EXCAVATION, CONSTRUCTION ACTIVITY, GRADE CHANGES, SURFACE TREATMENT OR STORAGE OF MATERIALS OF ANY KIND IS PERMITTED WITHIN THE TPZ


4. BRACING IS PERMISSIBLE WITHIN THE TPZ. INSTALLATION OF SUPPORTS TO AVOID DAMAGING ROOTS 5. PRUNING & MAINTENANCE TO TREE

AMENITY TREES

REFER TO AS 4373-2007 PRUNING OF

PROVIDE FENCING AS DETAILED TO ALL TREES PROPOSED TO BE RETAINED ON THE SUBJECT SITE. FENCING TO BE LOCATED TO THE DRIP LINE OF TREES OR AS INDICATED ON PLANS OR DIRECTED ON-SITE BY ARBORIST. NO STOCKPILING WITHIN FENCE PERIMETERS.

TREE PROTECTION ZONE

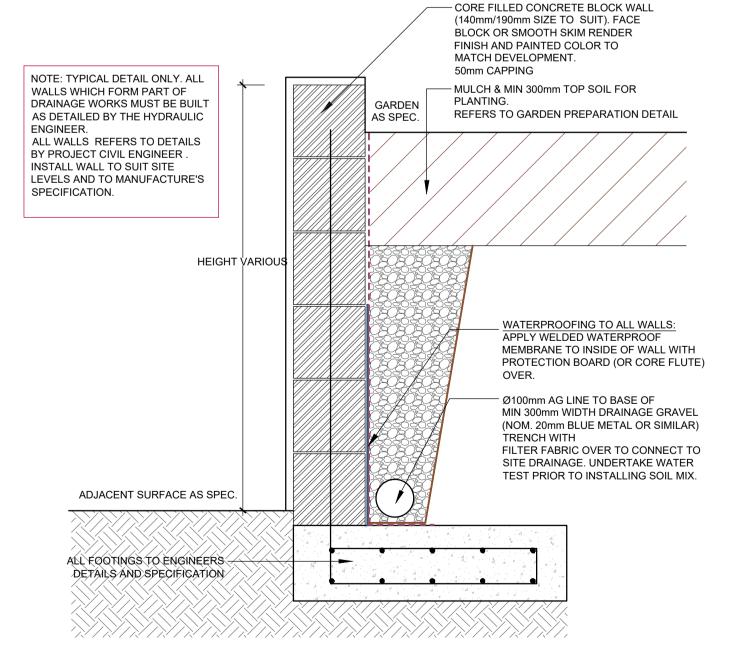

TYPICAL MASONRY BLOCK RETAINING WALL

DETAILS & SPECIFICATION DEVELOPMENT APPLICATION MAY 2024 AS SHOWN @ A1 R.F LPDA 24 - 04

screpancies to the Landscape Architect before proceeding with the work. Copyright Sulphurcrest Enterprises Pty Ltd Trading as CONZEPT (ABN: 75 623 405 630) cted by copyright. All rights are reserved. Unless permitted means be reproduced, published, broadcast or transmitted without the prior

